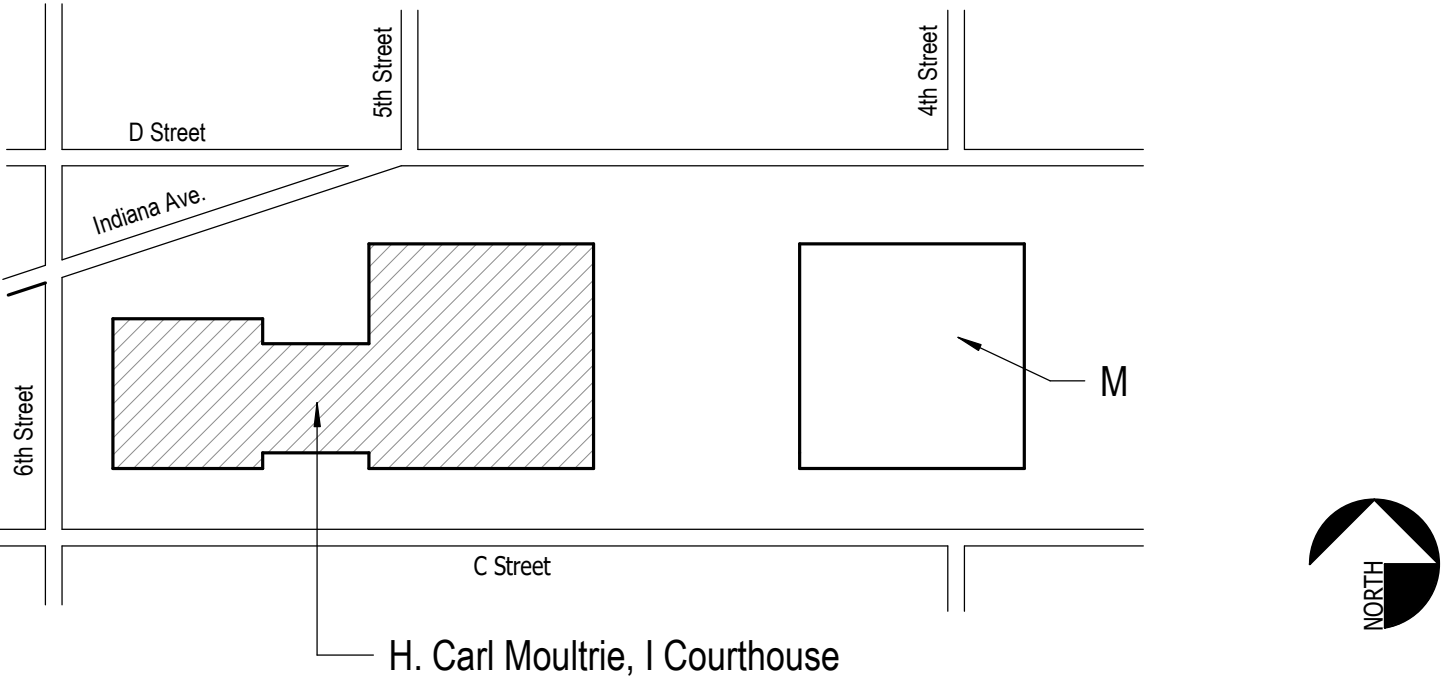


H. CARL MOULTRIE I COURTHOUSE - FOURTH FLOOR EAST SECURE SUPPORT SPACES RENOVATION

SHEET LIST		PROJECT DESCRIPTION	VICINITY MAP	500 INDIANA AVENUE N.W. WASHINGTON DC 20001
SHEET NUMBER	SHEET NAME			
GENERAL		THE SCOPE OF THE WORK IS A LEVEL 2 ALTERATION OF INTERIOR OFFICE SPACE. THE PROJECT HAS 2 PHASES THAT WILL RESULT IN THE COMPLETION OF CONSTRUCTION, TESTING COMMISSIONING AND OCCUPANCY OF THE MAGISTRATE SUITE ON THE FOURTH FLOOR.		
2.G.000	COVER SHEET			
2.G.001	BUILDING CODE ANALYSIS & LIFE SAFETY PLAN	1. PHASE 1 SCOPE IS SHOWN AS 2A WORK OF DEMOLITION AND RECONFIGURED LAYOUT TO INCLUDE PRIVATE OFFICES, OPEN WORKSTATIONS, LUNCH ROOM, COPY ROOMS, RESTROOMS AND STORAGE/CLOSETS. THIS WILL INCLUDE THE COMPLETION OF DOORS, CLERESTORY WINDOWS, FINISHES, MECHANICAL, ELECTRICAL, FIRE ALARM/FIRE PROTECTION, AV, DATA, APPLIANCES AND PLUMBING.		
2.G.002	PHASING PLAN - FOURTH FLOOR			
ARCHITECTURAL		2. PHASE 2 SCOPE IS SHOWN AS 2B WORK OF DEMOLITION AND RECONFIGURED LAYOUT TO INCLUDE PRIVATE OFFICES, OPEN WORKSTATIONS, CORRIDORS, RESTROOMS AND CLOSETS. THIS WILL INCLUDE THE COMPLETION OF DOORS, CLERESTORY WINDOWS, FINISHES, MECHANICAL, ELECTRICAL, FIRE ALARM/FIRE PROTECTION, AV, DATA AND PLUMBING.		
2.A.001	ABBREVIATIONS AND SYMBOLS			
2.A.002	TYPICAL TOILET ROOM MOUNTING HEIGHTS AND STALL CONFIGURATION DIAGRAMS			
2.A.004	TYPICAL RULES FOR DETERMINING MOUNTING HEIGHTS AND LOCATIONS			
2.A.005	TYPICAL REFLECTED CEILING PLAN LOCATIONS AND CONFIGURATIONS			
2.AD.204	DEMOLITION FLOOR PLAN - FOURTH FLOOR			
2.AD.304	DEMOLITION REFLECTED CEILINGS PLAN - FOURTH FLOOR			
2.A.204	FLOOR PLAN - FOURTH FLOOR			
2.A.304	REFLECTED CEILING PLAN - FOURTH FLOOR			
2.A.701	ENLARGED RESTROOM PLANS & INTERIOR ELEVATIONS			
2.A.702	ENLARGED RESTROOM PLANS & INTERIOR ELEVATIONS			
2.A.703	ENLARGED PLAN			
2.A.801	INTERIOR ELEVATIONS			
2.A.910	FINISH SCHEDULE			
2.A.920	PARTITION SYSTEMS			
2.A.921	PARTITION SYSTEMS DETAILS - FRAMING			
2.A.930	DOOR HARDWARE AND SCHEDULE			
2.A.960	MODULAR CASEWORK SECTIONS			
2.A.961	MISCELLANEOUS INTERIOR AND CEILING DETAILS			
2.AF.404	FINISH FLOOR PLAN - FOURTH FLOOR			
2.AI.504	FURNITURE PLAN - FOR REFERENCE ONLY			
2.AJ.604	POWERSIGNAL COORDINATION PLAN - FOURTH FLOOR			
FIRE PROTECTION				
2.FP.001	FIRE SUPPRESSION ABBREVIATIONS AND SYMBOLS			
2.FP.204	FOURTH LEVEL FIRE SUPPRESSION PLAN			
PLUMBING				
2.P.001	PLUMBING ABBREVIATIONS /SYMBOLS/GENERAL NOTES			
2.PD.204	FOURTH LEVEL PLUMBING DEMOLITION PLAN			
2.P.204	FOURTH LEVEL PLUMBING PLAN COMPLETION			
2.P.401	PLUMBING ENLARGED PLANS			
2.P.501	PLUMBING DIAGRAMS			
2.P.701	PLUMBING SCHEDULES			
MECHANICAL				
2.M.001	MECHANICAL ABBREVIATIONS AND SYMBOLS			
2.MD.204	MECHANICAL DEMOLITION PLAN - LEVEL 04			
2.M.204	HVAC PLAN - LEVEL 04			
2.M.304	HVAC PIPING PLAN - LEVEL 04			
2.M501	FIN TUBE RADIATOR RISER DIAGRAM			
2.M601	MECHANICAL DETAILS			
2.M701	MECHANICAL SCHEDULES			
2.M.801	MECHANICAL CONTROLS ABBREVIATIONS AND SYMBOLS			
2.M.802	MECHANICAL CONTROLS			
ELECTRICAL				
2.E.001	ELECTRICAL ABBREVIATIONS AND SYMBOLS			
2.E.002	ELECTRICAL SCHEDULES			
2.ED.204	DEMOLITION POWER PLAN - FOURTH FLOOR			
2.ED.304	DEMOLITION LIGHTING PLAN - FOURTH FLOOR			
2.E.204	POWER FLOOR PLAN -FOURTH FLOOR			
2.E.304	LIGHTING FLOOR PLAN - FOURTH FLOOR			
2.E.504	ELECTRICAL DIAGRAMS			
2.E.601	ELECTRICAL DETAILS			
2.E.701	LIGHTING SCHEDULES & COMCHECK LPD COMPLIANCE			
2.E.702	PANELBOARD SCHEDULES			
FIRE ALARM				
2.FA.001	FIRE ALARM ABBREVIATIONS AND SYMBOLS			
2.FA.104	FOURTH LEVEL FIRE ALARM PLAN			
IT-AV				
2.T.001	TECHNOLOGY INFRASTRUCTURE LEGENDS AND LEGEND NOTES			
2.T.002	TECHNOLOGY INFRASTRUCTURE LEGENDS, SCHEDULES AND GENERAL NOTES			
2.T.003	DIVISION 27 - AUDIOVISUAL SPECIFICATIONS			
2.T.204	TECHNOLOGY INFRASTRUCTURE FLOOR PLAN - LEVEL 4			
2.T.304	TECHNOLOGY INFRASTRUCTURE REFLECTED CEILING PLAN - LEVEL 4			
2.T.504	TELECOM PLAN, ENLARGED PLANS AND ELEVATIONS - LEVEL 4			
2.T.601	AUDIOVISUAL INFRASTRUCTURE ROOM RISERS			
2.T.602	AUDIOVISUAL SYSTEMS DRAWING			
2.T.701	TELECOM BUILDING AND TYPICAL CONDUIT RISER			
2.T.801	TECHNOLOGY INFRASTRUCTURE ELEVATIONS			
2.T.901	TECHNOLOGY INFRASTRUCTURE DETAILS			
2.T.902	TELECOM DETAILS			



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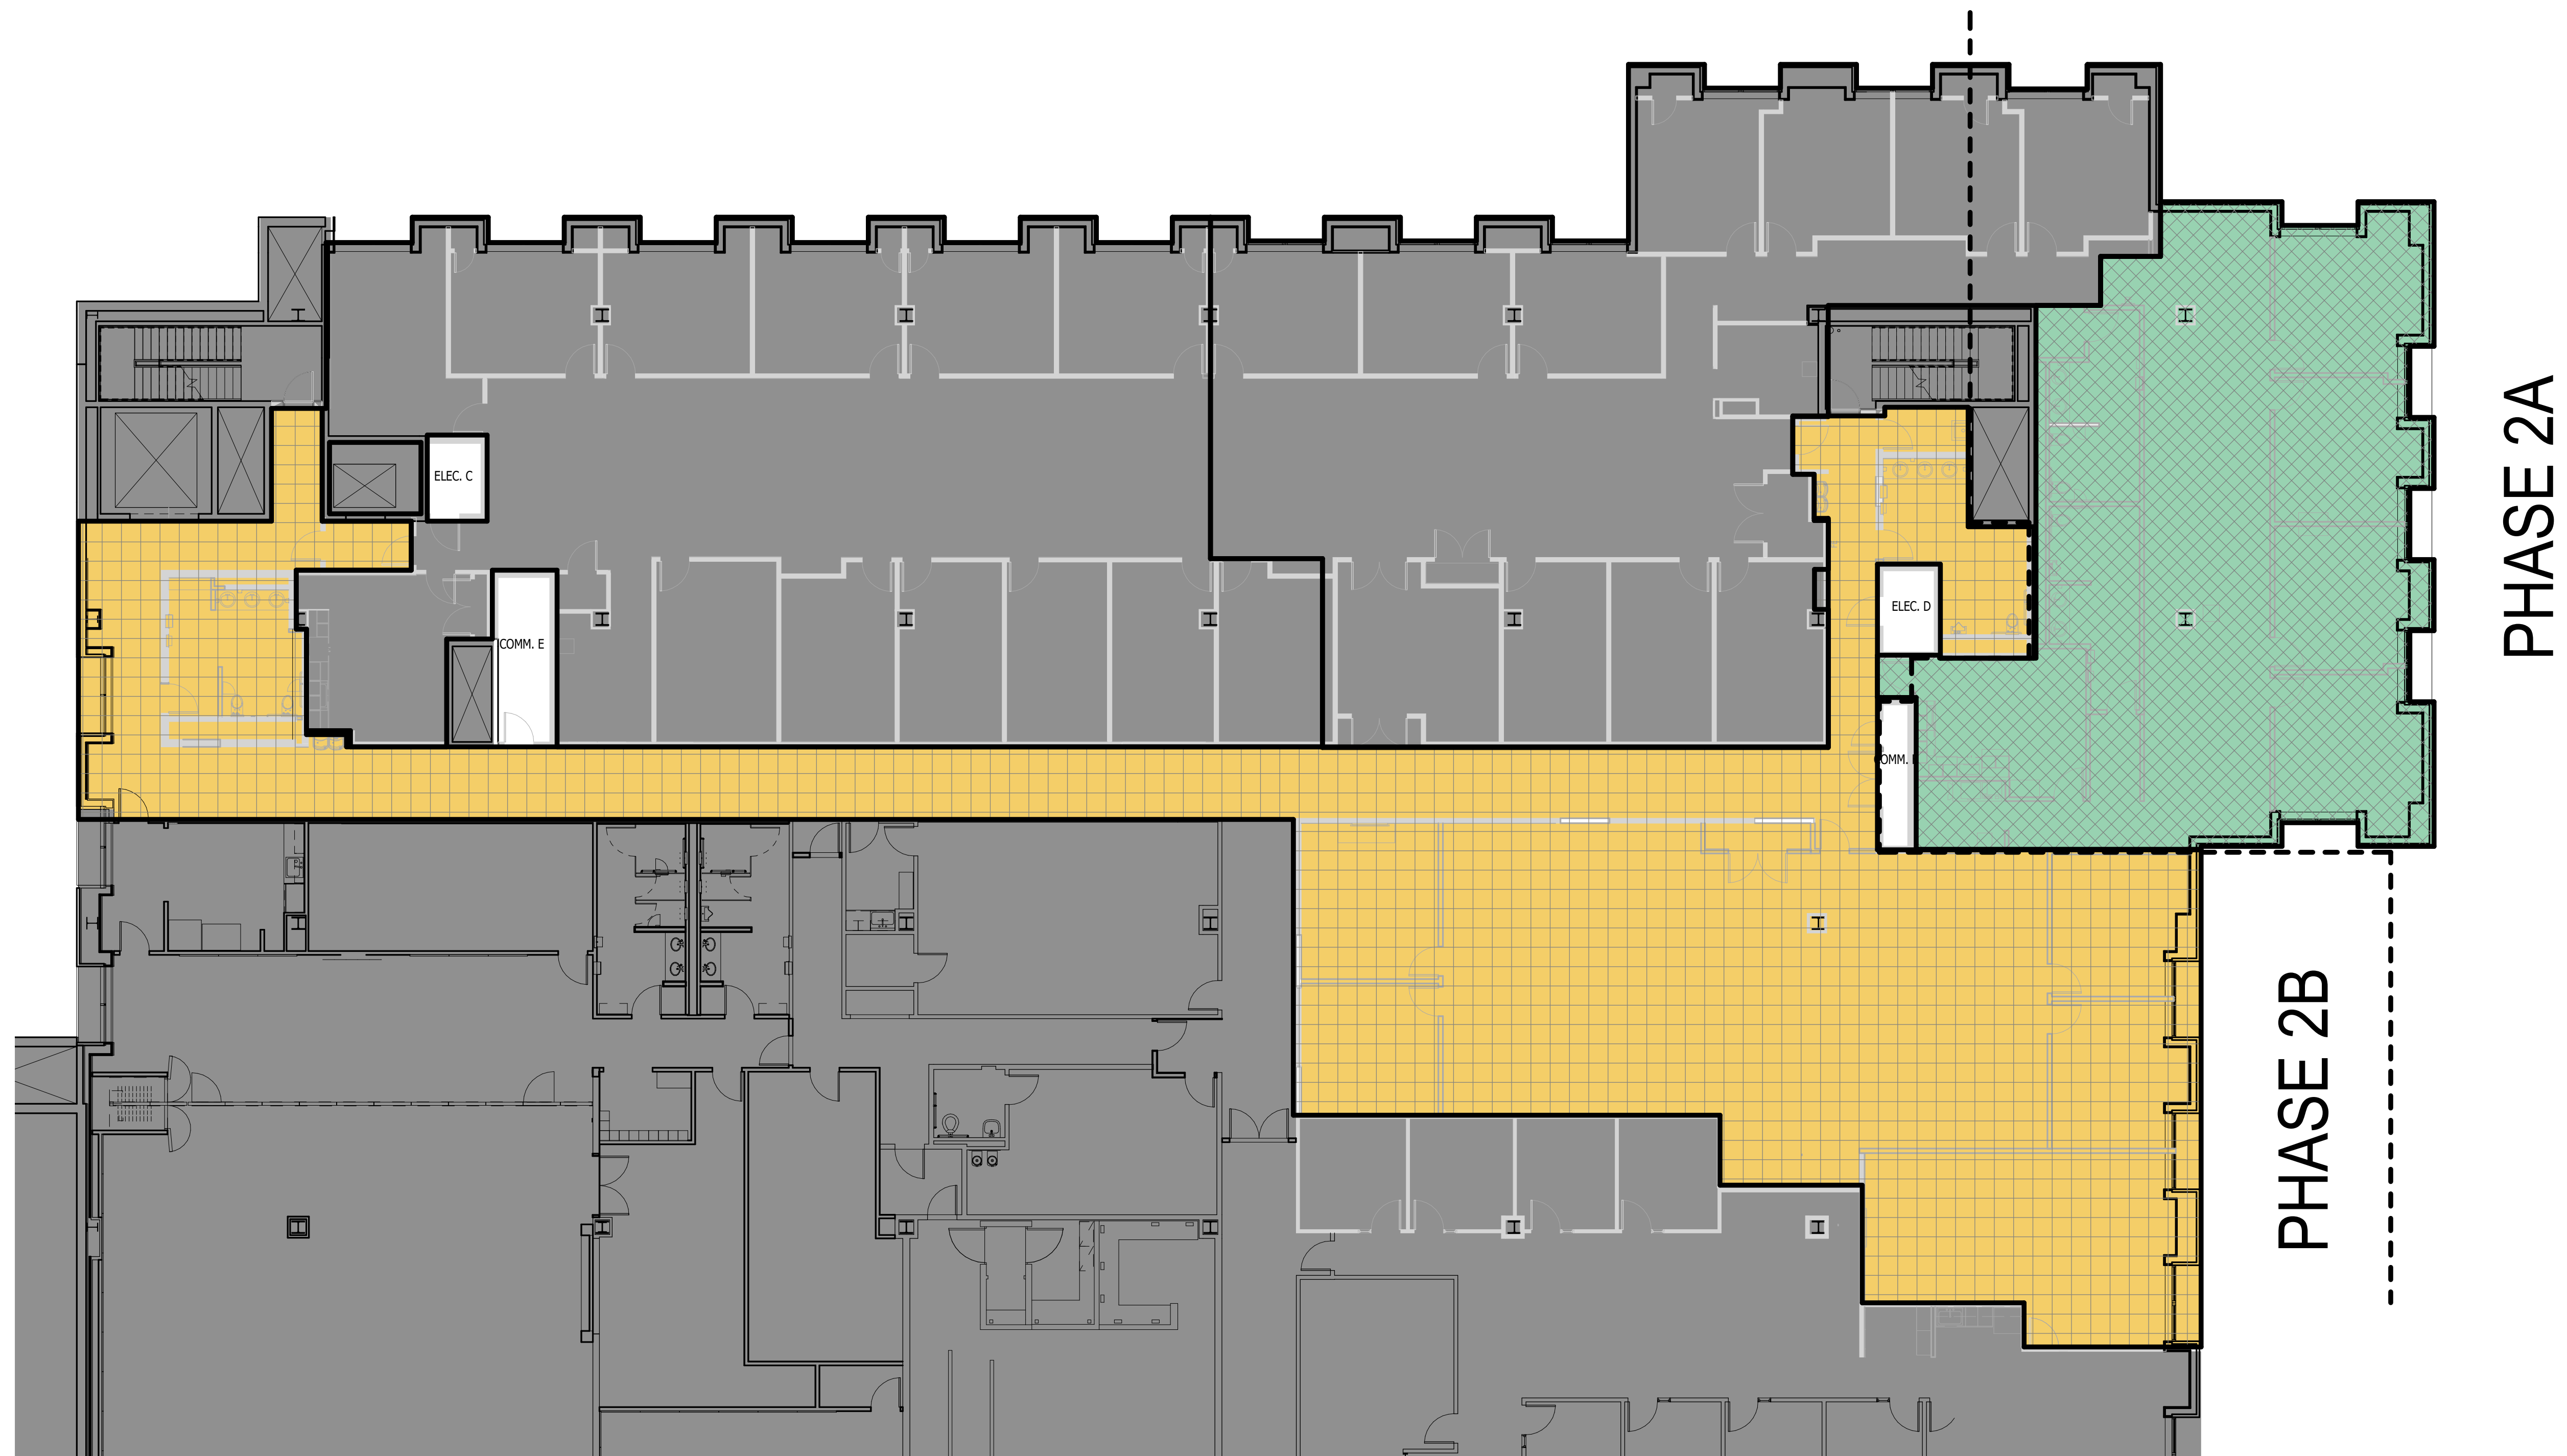
VOLUME I OF I

ISSUED FOR:
ISSUED FOR CONSTRUCTION

CPFMD Reference #: 0017-01-400-3

ISSUE DATE:
06/04/2021

12808



1 FOURTH FLOOR PHASING PLAN
SCALE: 1" = 10'-0"



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 500 INDIANA AVENUE N.W.
 WASHINGTON DC 20001

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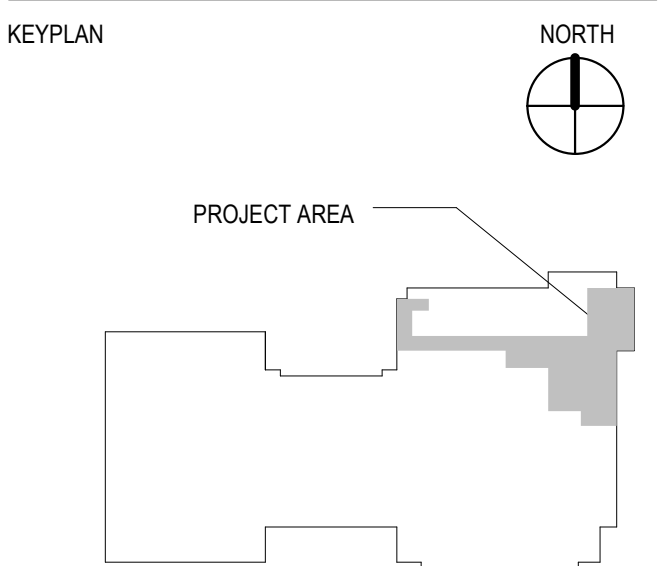
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301-371-6047

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SEALS AND SIGNATURES



SHEET TITLE

PHASING PLAN - FOURTH
FLOOR

PROJECT NUMBER

CD

SHEET NUMBER

12808

2.G.002

TYPICAL TOILET COMPARTMENT ACCESSORY MOUNTING HEIGHTS

4'-0" MAX FOR CONTROLS

2'-5" TYP FOR CONTROLS

2'-5" TYP GRAB BAR

TOP OF UNIT

2'-5"

TOILET TISSUE DISPENSERS (RECESSED)

TOP OF UNIT

2'-5"

TOP OF UNIT

1'-8"

(CENTERED IN PARTITION)

DISPENSER

3'-4" TYP 1'-3" MIN

SEAT - COVER DISPENSER (SURFACE)

TOP OF UNIT

2'-6"

2'-6" (SURFACE MTD)

SANITARY NAPKIN DISPOSAL (RECESSED - SHOWN)

5'-0" NON-ACCESSIBLE

TOP OF UNIT

2'-8" ACCESSIBLE

PARTITION MOUNTED OR RECESSED

COMBINATION TOILET COMPARTMENT ACCESSORIES

TOP OF UNIT

2'-6"

SANITARY NAPKIN DISPOSAL / TOILET TISSUE DISPENSER

TYPICAL LAVATORY AREA ACCESSORY MOUNTING HEIGHTS

4'-0" MAX FOR CONTROLS

3'-2" MIN FOR CONTROLS

DISPENSER

3'-4"

PAPER TOWEL DISPENSERS

4'-1" TO 4'-5" RECOMMENDED

TOP OF UNIT

WASTE RECEPTACLES

(RECESSED)

2'-5 1/2" MIN
3'-2" MAX

TOP OF UNIT

5'-2" RECOMMENDED

PAPER TOWEL DISPENSER / WASTE RECEPTACLES

(RECESSED & FULLY RECESSED)

DISPENSER

3'-4"

COIN SLOT

3'-4"

SANITARY NAPKIN / TAMPON VENDORS (RECESSED & SURFACE)

PUSH BUTTON

2'-8" RECOMMENDED

SOAP DISPENSERS

3'-2" RECOMMENDED

HAND DRYER (SURFACE)

3'-4" MAX ABOVE LAVATORY

2'-6" MIN OTHER LOCATIONS (TO BOTTOM OF REFLECTIVE SURFACE)

ALL FRAMED MIRRORS (SURFACE)

GENERAL MOUNTING HEIGHT NOTES

- IT IS THE INTENT OF THE DESIGN THAT ALL ITEMS SHOWN WITHOUT A TYPICAL HEIGHT BE ACCESSIBLE TO PERSONS WITH DISABILITIES.
- THE PURPOSE OF THIS SHEET IS TO ILLUSTRATE TYPICAL MOUNTING HEIGHTS AND - WHERE APPLICABLE - TYPICAL MINIMUM OR MAXIMUM CLEARANCES AND/OR TYPICAL MOUNTING CONFIGURATIONS FOR THE ITEMS SHOWN ON THIS CAUTION: THIS SHEET WILL ILLUSTRATE ITEMS OR CONFIGURATIONS WHICH DO NOT OCCUR AS PART OF THE WORK OF THIS PROJECT. REFER TO THE PLANS, ELEVATIONS, SECTIONS, DETAILS, AND SCHEDULES TO DETERMINE WHICH ITEMS AND CONFIGURATIONS APPLY TO THE WORK OF THIS PROJECT.
- SPECIAL OR NON-TYPICAL MOUNTING HEIGHTS OCCUR ONLY WHEN INDICATED BY A TOLERATED SYMBOL(S) BY KEYED NOTES, BY NOTES ON PLANS, ELEVATIONS, OR DETAILS, OR BY UNIQUE DIMENSIONS ON ELEVATIONS OR DETAILS.
- MOUNTING HEIGHTS, DIMENSIONS, CLEARANCES, AND ACCESS REQUIREMENTS FOR TOILET ACCESSORIES SHOWN ON THIS SHEET ARE BASED UPON SPECIFIC MANUFACTURERS AND MODELS AS INDICATED BY THE "TOILET ACCESSORY SCHEDULE" OR PER THE SPECIFICATIONS. WHEN SIMILAR ACCESSORIES OF OTHER SPECIFIED, ACCEPTABLE MANUFACTURERS (IF ANY) ARE UTILIZED MOUNTING HEIGHTS, DIMENSIONS, CLEARANCES, AND ACCESS REQUIREMENTS OF THE SIMILAR ACCESSORIES MAY VARY FROM THOSE SHOWN. WHEN MANUFACTURER ACCESSORIES ARE USED, THE MANUFACTURER SHALL BE RESPONSIBLE FOR ALL COORDINATION.



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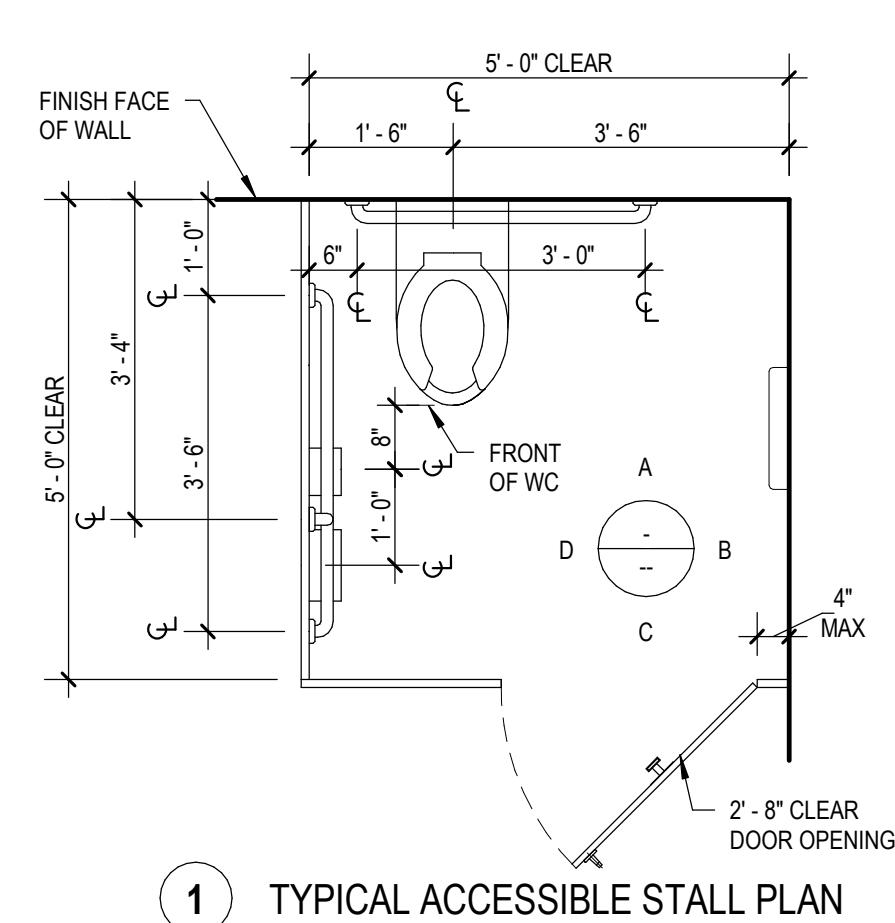
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SEALS AND SIGNATURES


TYPICAL SHOWER AREA AND MISCELLANEOUS ACCESSORY MOUNTING HEIGHTS

Accessory	Mounting Height
SHOWER CURTAIN ROD	4'-0" MAX FOR CONTROLS (3'-2" MIN. FOR CONTROLS)
RECESSED SHOWER STALL SOAP DISH	6'-4"
FOLDING SHOWER SEAT	3'-4"
FOLDING SHOWER / DRESSING AREA SEAT	MOUNT FOLDING SEATS SO THAT SEAT IS 18" AFF WHEN FOLDED DOWN.
ROBE HOOK (ACCESSIBLE)	4'-0" TYP.
ROBE HOOK (TYPICAL)	5'-6"
RECESSED SHOWER STALL	4'-0" (NON-ACCESSIBLE)
CLOTHES HOOK AND BUMPER	5'-0" (NON-ACCESSIBLE)
FOLDING UTILITY SHELF	1'-5" (TOP OF UNIT)
STAINLESS STEEL SHELF (BELOW GRAB BAR)	6" (TOP OF UNIT)
MOP & BROOM HOLDER (NON-ACCESSIBLE)	6'-0" (TOP OF UNIT)
SHELF WITH MOP & BROOM HOLDER & HOOKS (NON-ACCESSIBLE)	5'-0" (TOP OF UNIT)
SHELF WITH MOP & BROOM HOLDER & HOOKS (NON-ACCESSIBLE)	5'-6" (TOP OF UNIT)
TOWEL BAR ALL TYPES	3'-4" TYP.
DIAPER CHANGING STATION (SURFACE MTD)	4'-0" (TOP OF UNIT)
FIXED SHOWER HEAD	6'-6"
FLEXIBLE 60" SHOWER SPRAY HOSE	5'-0" (TO TOP OF BRACKET)
FLEXIBLE 90" BATHTUB SHOWER SPRAY HOSE	5'-0" (TO TOP OF BRACKET)
SINGLE LEVER SHOWER MIXING VALVE	3'-4" (3'-2" MIN. FOR CONTROLS)


TYPICAL ACCESSIBLE RESTROOM STALL CONFIGURATION DIAGRAMS



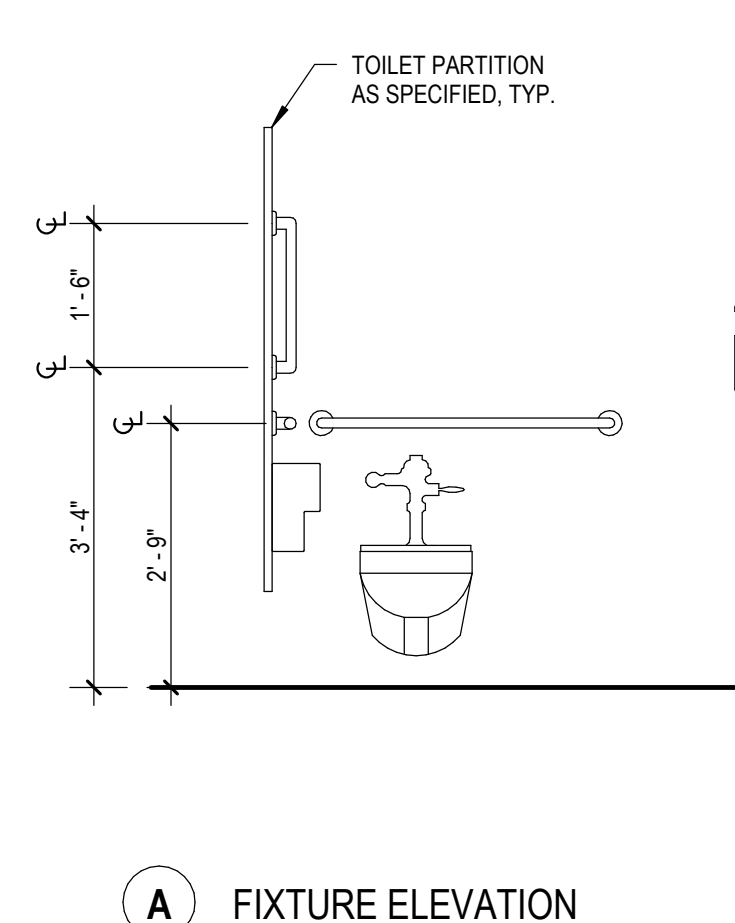
1 TYPICAL ACCESSIBLE STALL PLAN




A FIXTURE ELEVATION

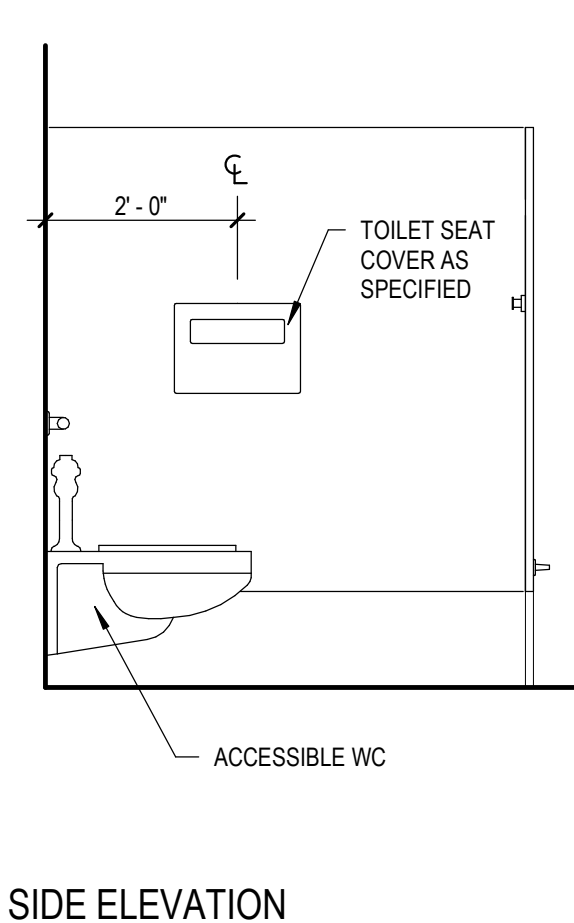

B SIDE ELEVATION

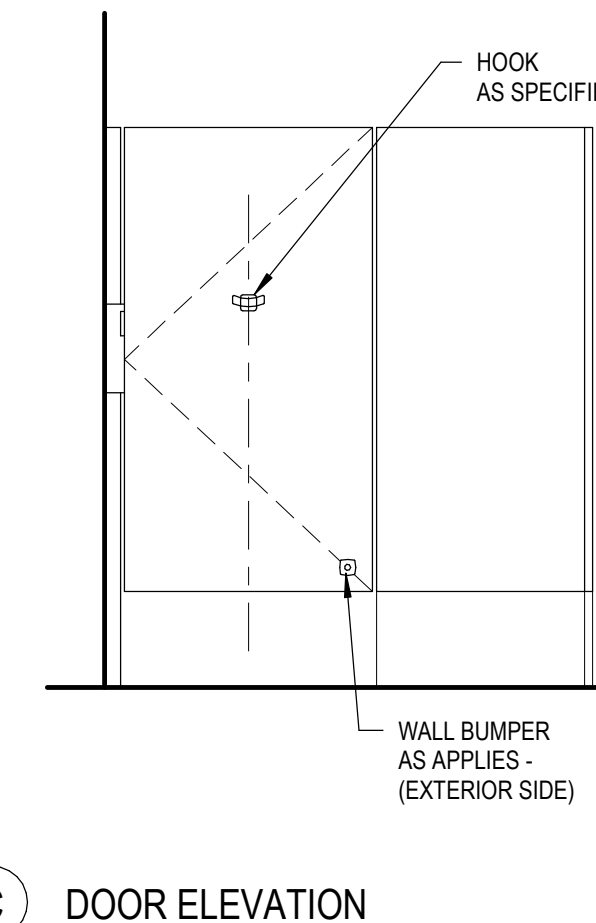


C DOOR ELEVATION

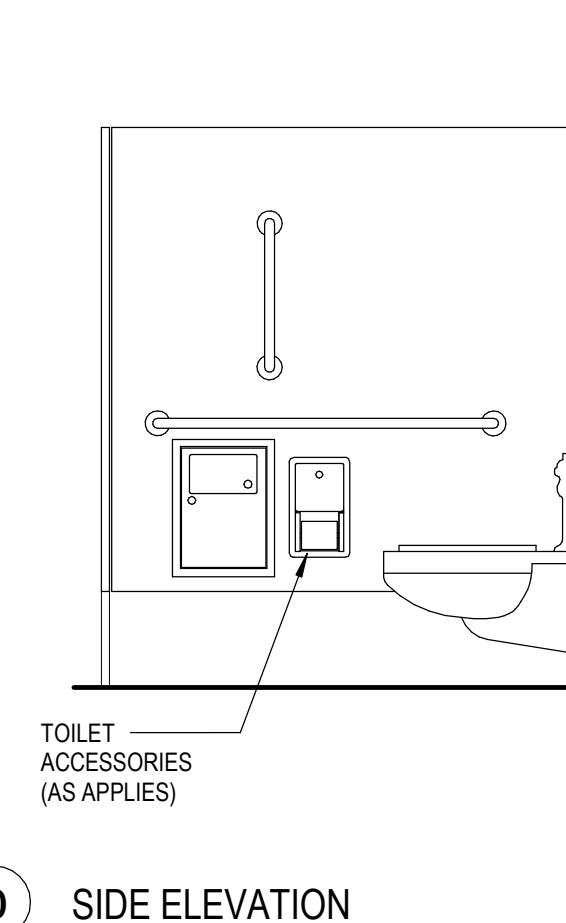


D SIDE ELEVATION


TYPICAL FIXTURE CLEARANCES	
----------------------------	--

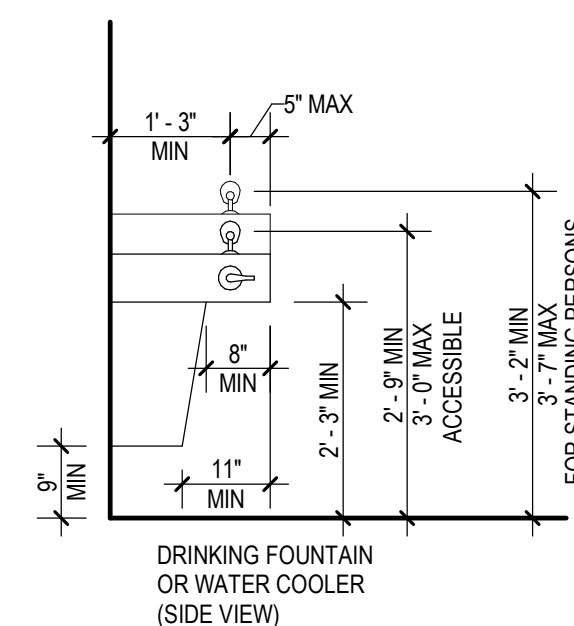

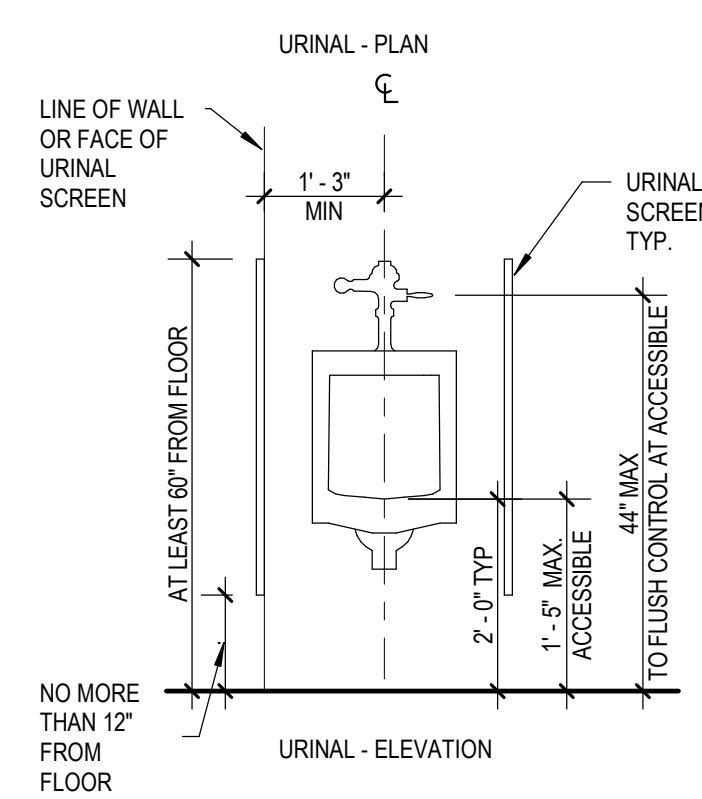
DRINKING FOUNTAIN
OR WATER COOLER
(SIDE VIEW)




URINAL - ELI

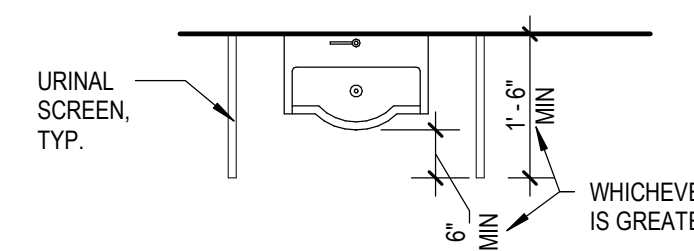

SCREEN
TYP.

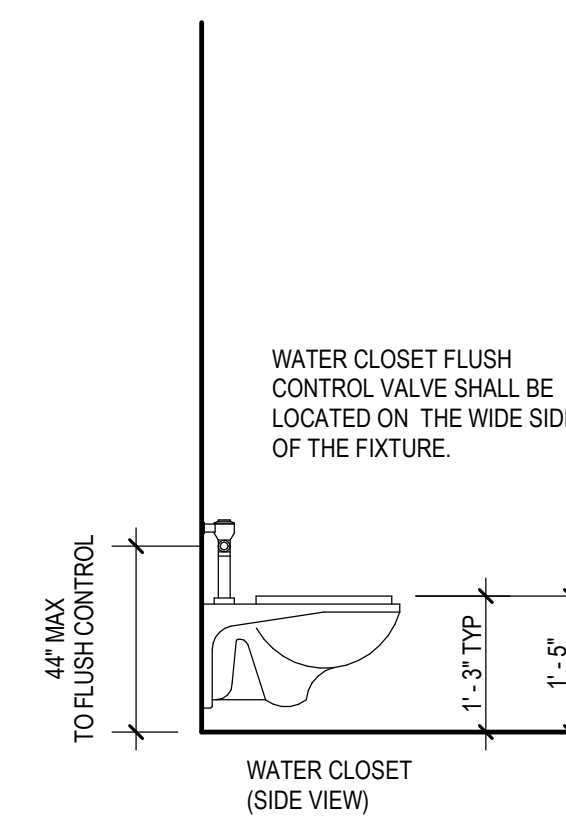

WATER CLOSET
(SIDE VIEW)

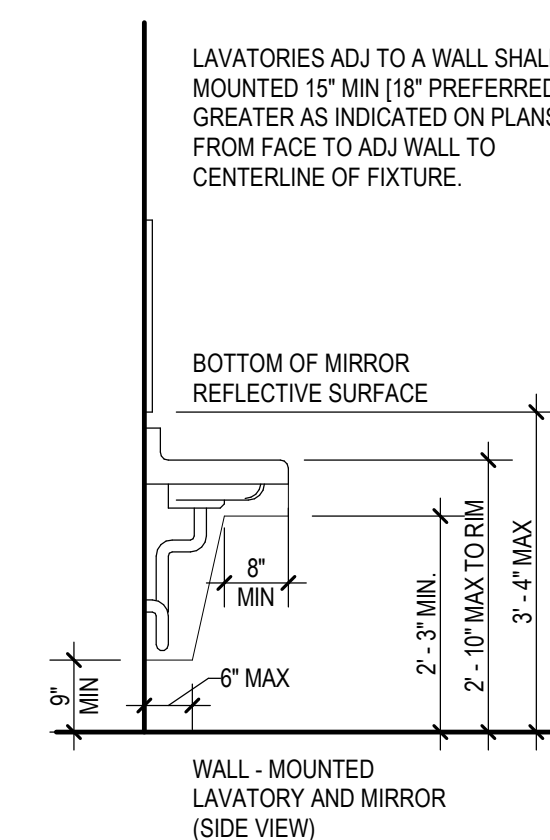

WALL - MOUNTED
LAVATORY AND MIRROR
(SIDE VIEW)

Author


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Plot Date:

SHEET TITLE

TYPICAL TOILET ROOM
MOUNTING HEIGHTS AND
STALL CONFIGURATION
DIAGRAMS

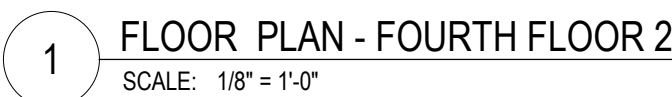PROJECT NUMBER
CD
SHEET NUMBER
2.A.002




	NOT IN SCOPE
	EXISTING PARTITION
	NEW PARTITION
	NEW MILLWORK


A. REFER TO THE A4 SERIES SHEETS FOR ARCHITECTURAL GENERAL NOTES, DRAWING, REFERENCE AND MATERIAL ABBREVIATIONS, AS WELL AS DIMENSIONING CONVENTIONS USED ON THIS SHEET.	F. REFER TO THE A2 SERIES SHEETS FOR INTERIOR FINISH INFORMATION.	K. FURNISH AND INSTALL FIRE RETARDANT TREATED WOOD BLOCKING AS REQUIRED AT ALL LOCATIONS FOR THE PROPER AND SECURE INSTALLATION OF ALL WALL MOUNTED EQUIPMENT OR MILLWORK WHETHER SPECIALLY NOTED IN THE DRAWINGS OR NOT.
B. FOR BASIC LIFE SAFETY AND CODE INFORMATION APPLYING TO THIS PROJECT, REFER TO THE 0002 SERIES SHEETS LOCATED PER THE PROJECT SHEET INDEX.	G. REFER TO THE A4 SERIES SHEETS FOR INTERIOR FURNISHINGS INFORMATION.	L. PROVIDE DEMOLITION TO THE MINIMUM EXTENT REQUIRED FOR THE INSTALLATION OF FIRE ALARM, SPRINKLER, MECH AND TELECOMMUNICATIONS WORK, UNLESS NOTED OTHERWISE. EXISTING FINISHES AND EQUIPMENT IN THE DESIGNATED AREAS ARE TO REMAIN AND SHOULD BE DISTURBED ONLY TO THE MINIMUM EXTENT TO PERFORM THE WORK. REPAIR OR REPLACE FINISHES THAT ARE DAMAGED AS A RESULT OF WORK TO MATCH SURROUNDING CONDITIONS.
C. REFER TO THE A2 SERIES SHEETS FOR THE REFLECTED CEILING PLANS.	H. DO NOT SCALE THESE DRAWINGS. FIELD VERIFY ANY DIMENSIONS DEMOLTED, OR NOTED AS BEING, CRITICAL.	
D. REFER TO THE A9 SERIES SHEETS FOR PARTITION SYSTEMS TYPES AND DETAILS.	I. VERIFY ALL DIMENSIONS AND EXISTING CONDITIONS AT JOB SITE AND ADVISE THE ARCHITECT OF ANY DISCREPANCIES, ADDITIONS, DELETIONS AND/OR ALTERATIONS IN ANY OR ALL CONDITIONS BEFORE PROCEEDING WITH ANY PHASE OF THE WORK.	
E. REFER TO THE A9 SERIES SHEETS FOR THE INTERIOR OPENING SCHEDULE(S), TYPES, AND DETAILS.	J. UNLESS NOTED OTHERWISE, ALL DIMENSIONS ARE FROM FINISH FACE TO FINISH FACE.	


A2-01	COORDINATE AND EXTEND GYB BAR HANGOUT ABOVE EXISTING HANGOUT AT PETERSEN AS REQUIRED.	A2-13	PATCH AND CLOSE NICHE AT EXISTING WATER FOUNTAIN LOCATION.
A2-02	TRANSOM WINDOWS, REFERENCE PARALLEL AT TOP OF OFFICES, REFERENCE ELEVATIONS 12/80001.	A2-14	COORDINATE WITH T.I. ELEC DRAWINGS AND SPECS FOR FIRE RATED PLYWOOD REQUIREMENTS.
A2-03	COORDINATE PARTITION CONSTRUCTION WITH EXISTING MECHANICAL, F.N. TUBE.	A2-15	PROVIDE BLOODING AS REQUIRED FOR TV MOUNTING. COORDINATE LOCATION OF MOUNTING BRACKET WITH TV OUTLETS. REFER TO AV DRAWING FOR ADDITIONAL INFORMATION.
A2-08	EXTENTS OF PHASE 2B WORK TO BE COORDINATED WITH 2B EXISTING CONDITIONS.		
A2-09	EXTENTS OF PHASE 2B WORK TO BE COORDINATED WITH 2A WORK.		
A2-10	PROVIDE 2 LAYERS OF NEW DRYWALL TO MATCH EXISTING PARTITION REQUIREMENTS.		
A2-11	PROVIDE AD ALTERNATE FOR GYP. BOARD LAYER TO BE REPLACED AT CORRIDOR PARTITION FOR ACM ABATEMENT SPECIFICATIONS.		

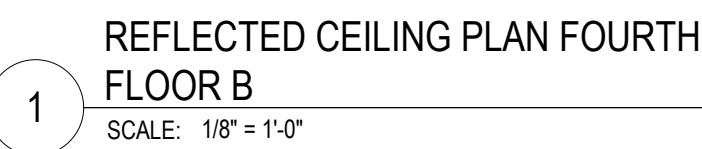2.A.204



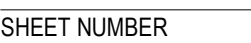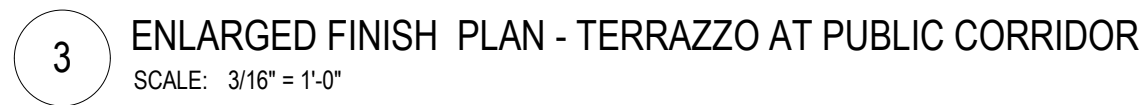A3-04 ALIGN CEILING GRID WITH ADJACENT CEILING GRID.
A3-05 CONTINUE ACT GRID FROM ADJACENT CORRIDOR GRID.
A3-06 (20) FULL ACT CENTERED IN ROOM.
A3-09 REFER TO E SERIES DRAWINGS FOR UNDERCABINET LIGHTING.





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SEALS AND SIGNATURES



PROJECT NUMBER
CD
SHEET NUMBER

2.A.703















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SEALS AND SIGNATURES

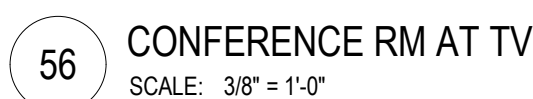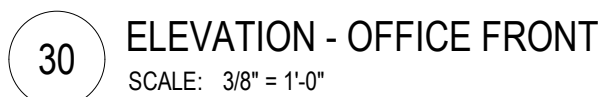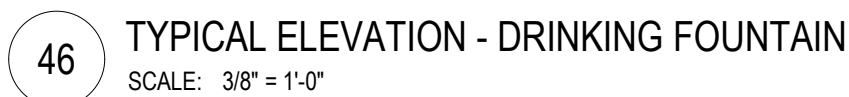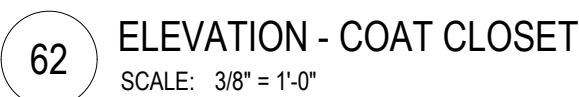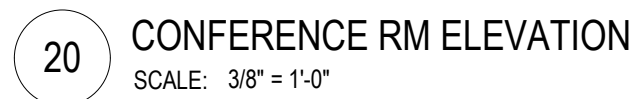
2.A.801





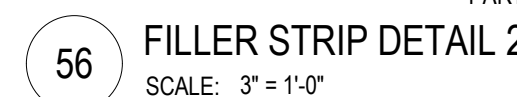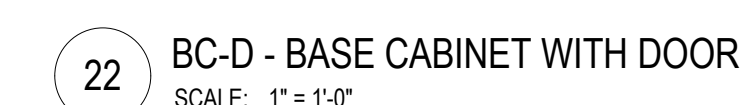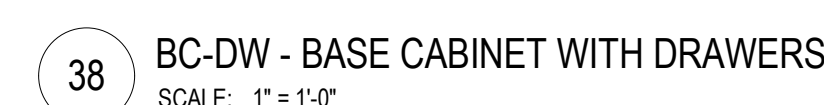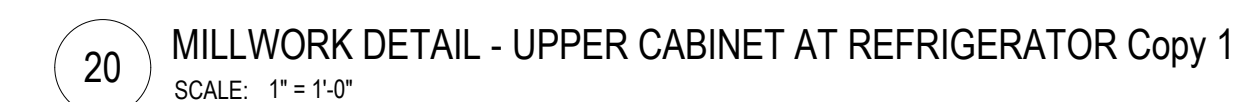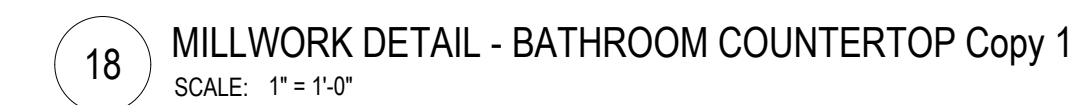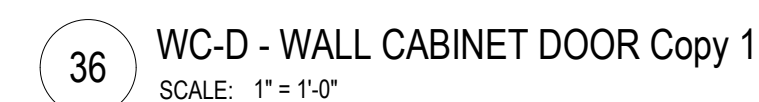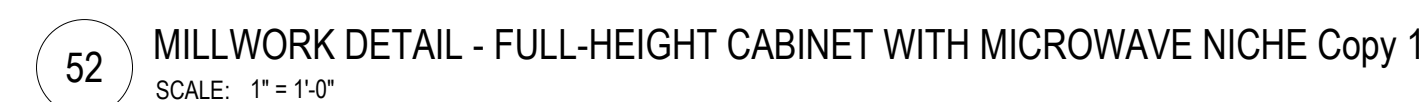- REFER INTERIOR ELEVATIONS FOR FINISHES & CASEWORK TAGS INDICATING EXTENTS AND CONFIGURATION OF MODULAR CASEWORK.
- CASEWORK IDENTIFICATION CODES ARE ILLUSTRATED BY THE EXAMPLES SHOWN BELOW:

LEGEND

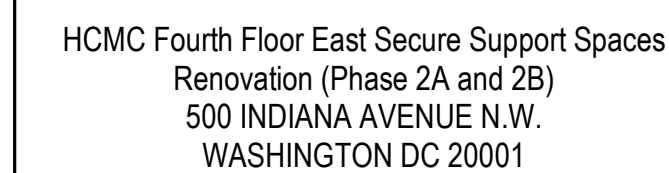

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SEALS AND SIGNATURES

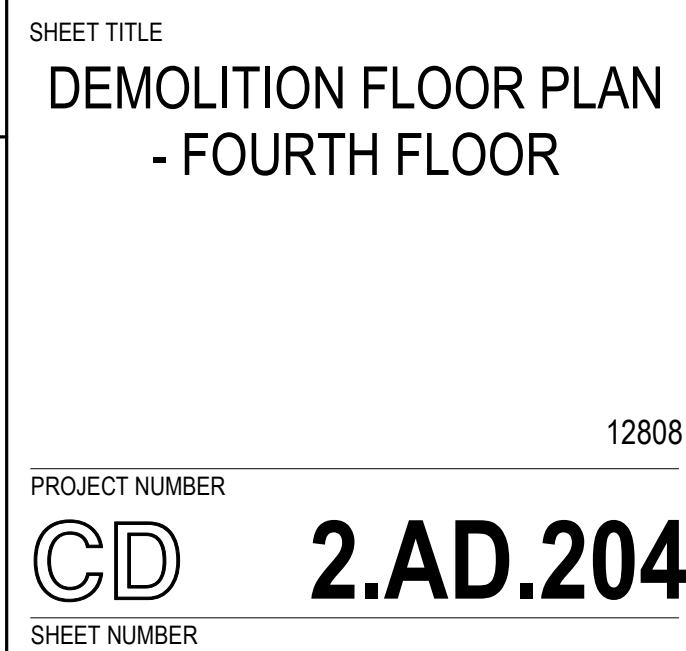
SHEET TITLE

MODULAR CASEWORK
SECTIONS

PROJECT NUMBER _____

CD
SHEET NUMBER

2.A.960



AD01	DEMO EXTPENTS TO INCLUDE PARTITION AND FLOOR FINISH PREP FOR NEW LAYOUT EXITS. COORDINATE WITH MECHANICAL WORK.	AD15	DEMO DRYALL AT PHASE EXTENTS OF WORK. COMPLETE DEMO OF ENTIRE PARTITION DURING THE LAST PHASE.
AD02	REMOVE DOORS AND DOOR HARDWARE AT JUVENILE SUITE TO BE RETURNED TO OWNER FOR RE-USE.	AD16	COMPLETE DEMO OF ENTIRE PARTITION DURING THE CURRENT PHASE.
AD03	DEMO COLUMN FURNISHING, PREP FOR NEW LAYOUT AND FLOOR COLUMN.	AD17	PROVIDE ADD ALTERNATE FOR GYP. BOARD LAYER TO BE REMOVED AT CORRIDOR PARTITION PER ACM ABATEMENT SPECIFICATIONS.
AD04	TILE FLOOR FINISH TO BE DEMOLISHED. PREP FOR NEW FINISHES AS REQUIRED.	AD18	GC TO PROVIDE TEMPORARY PARTITION PRIOR TO CONSTRUCTION AND TO BE REMOVED AT COMPLETION OF WORK.
AD05	REMOVE PHASE 1B PARTITION WITH ADJACENT SUITE. CAREFULLY DEMO PARTITION EXITS AND PREP FOR NEW PLAN LAYOUT. REFER TO SHEET A3004 REFLECTED GLASS PLAN.	AD19	SALVAGE FIRE EXTINGUISHER AND CABINET FOR RE-USE. COORDINATE WITH NEW PLAN FOR LOCATION.
AD06	COORDINATE WITH OWNER FURNITURE TO BE REMOVED FOR RE-USE.	AD20	EXISTING DRYALL TO BE REFINISHED TO MATCH STANDARD STAIN. NEW HARDWARE TO BE INSTALLED. FINISH TO MATCH BUILDING STAINLESS STEEL STANDARD. REFER TO OWNER HARDWARE SCHEDULE FOR SPECIFICATION.
AD07	DEMO EXTPENTS OF EXISTING PARTITION AND FLOORING UNDER CORRIDOR DURING PHASE 1B.	AD21	



EXISTING PARTITION TO REMAIN

EXISTING PARTITION TO BE REMOVED

EXISTING DOOR TO REMAIN

EXISTING DOOR AND FRAME TO BE REMOVED

EXISTING WINDOW TO
REMAIN

EXISTING WINDOW TO
BE REMOVED

EXISTING LAY-IN
CEILING TO
REMAIN

EXISTING LAY-IN
CEILING TO BE
REMOVED

A. REFER TO THE A/D X SERIES SHEETS FOR ARCHITECTURAL GENERAL NOTES, DRAWING, REFERENCE AND MATERIAL SYMBOLS, ABBREVIATIONS, AS WELL AS DIMENSIONING CONVENTIONS USED ON THIS DRAWING.

B. EXISTING CONDITIONS SHOWN ARE FROM AVAILABLE RECORD DRAWINGS AND VISUAL FIELD SURVEYS. THE CONTRACTOR SHALL VERIFY THE ACTUAL EXISTING CONDITIONS AT THE SITE PRIOR TO SUBMITTING A BID. THE CONTRACTOR SHALL NOTIFY THE ARCHITECT OF ANY DISCREPANCIES.

C. DEMOLITION WORK SHALL BE DONE IN A MANNER WHICH WILL NOT CAUSE UNNECESSARY INCONVENIENCE OR DANGER TO USERS OF THE PREMISES AND ADJACENT AREAS AND NOT INTERFERE WITH ITS OPERATION. ANY DEMOLITION WORK TO BE PERFORMED MUST BE PLANNED IN ADVANCE AND APPROVED BY THE OWNER.

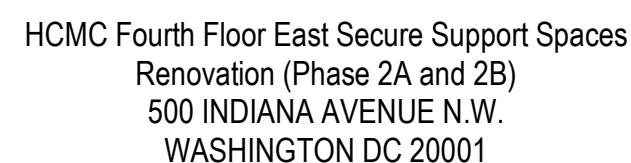
- D. ANY EQUIPMENT, MATERIALS, AND SUPPLIES TEMPORARILY REMOVED FOR THE PURPOSE OF PROTECTION SHALL BE REPLACED IN ORIGINAL LOCATIONS AND CONDITIONS. ANY MATERIALS DAMAGED SHALL BE REPLACED WITH NEW MATERIALS OF LIKE KIND AND QUALITY.
- E. REFER TO AND COORDINATE WITH MECHANICAL, PLUMBING, AND ELECTRICAL DRAWINGS FOR ADDITIONAL DEMOLITION INFORMATION NOT SHOWN ON THIS DRAWING.
- F. ALL MATERIALS INDICATED TO BE REMOVED SHALL BE DISPOSED OF PROPERLY AND REMOVED FROM THE SITE.
- G. ALL REMOVED MATERIALS AND EQUIPMENT WHICH IS CLASSIFIED AS "SALVAGE FOR OWNER" SHALL REMAIN THE PROPERTY OF THE OWNER. DELIVER SUCH MATERIALS AND EQUIPMENT ON THE PREMISES AS DIRECTED BY THE OWNER AND NEATLY STORE AND PROTECT FROM DAMAGE.

- H. ALL REMOVED MATERIALS AND EQUIPMENT WHICH IS CLASSIFIED "SALVAGE FOR RELOCATION" SHALL REMAIN THE PROPERTY OF THE OWNER. THE CONTRACTOR IS RESPONSIBLE FOR PLACING ITEMS IN STORAGE ON SITE AND FOR THE PROTECTION OF THOSE ITEMS. THESE ITEMS WILL BE RELOCATED. REFER TO THE FLOOR PLANS FOR NEW LOCATIONS.
- I. PATCH AND REPAIR ALL ELEMENTS THAT ARE TO REMAIN WHICH ARE DAMAGED FROM THE DEMOLITION WORK WITH CONSTRUCTION TO MATCH EXISTING CONDITIONS.
- J. REFER TO ACM SPECIFICATIONS FOR AREAS AS NOTED.

H. ALL REMOVED MATERIALS AND EQUIPMENT WHICH IS CLASSIFIED "SALVAGE FOR RELOCATION" SHALL REMAIN THE PROPERTY OF THE OWNER. THE CONTRACTOR IS RESPONSIBLE FOR PLACING ITEMS IN STORAGE ON SITE AND FOR THE PROTECTION OF THOSE ITEMS. THESE ITEMS WILL BE RELOCATED. REFER TO THE FLOOR PLANS FOR NEW LOCATIONS.

- I. PATCH AND REPAIR ALL ELEMENTS THAT ARE TO REMAIN WHICH ARE DAMAGED FROM THE DEMOLITION WORK WITH CONSTRUCTION TO MATCH EXISTING CONDITIONS.
- J. REFER TO ACM SPECIFICATIONS FOR AREAS AS NOTED.

AD203 EXISTING CEILING LIGHTS TO BE SALVAGED AND RE-USED
IN THE NEW WORK THROUGHOUT THE SUITE



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SEALS AND SIGNATURES

NOR



FINISH FLOOR PLAN - FOURTH FLOOR

2.AF.404

12808



PHASE 2B

SCALE: 1/8" = 1'-0"

Diagram illustrating the components of a room schedule form:

- Room Name
- 101
- Wall
- Base
- Floor
- ROOM NAME
- ROOM NUMBER
- WALL FINISH
- BASE FINISH
- FLOOR FINISH

Diagram illustrating the components of a room schedule form:

- Room Name
- 101
- Wall
- Base
- Floor
- ROOM NAME
- ROOM NUMBER
- WALL FINISH
- BASE FINISH
- FLOOR FINISH

 MILL WORK

- A. REFER TO THE A0 X SERIES SHEETS FOR ARCHITECTURAL GENERAL NOTES, DRAWING, REFERENCE AND MATERIAL SYMBOLS, ABBREVIATIONS, AS WELL AS DIMENSIONING CONVENTIONS USED ON THIS SHEET.
- B. REFER TO THE A8 X SERIES SHEETS FOR ADDITIONAL INFORMATION NOT SHOWN ON THIS SHEET.
- C. ALL FINISHES SHALL BE APPLIED IN CONFORMANCE WITH MANUFACTURER'S RECOMMENDATIONS AND INSTRUCTION. A COPY OF THE RECOMMENDATIONS AND INSTRUCTIONS SHALL BE SUBMITTED TO THE DESIGNER PRIOR TO THE INSTALLATION OF MATERIALS.

D. UNLESS OTHERWISE NOTED, ALL PAINT, PAINTING AND PRIMING FOR WALLCOVERINGS AND WALLPAPER ARE TO BE FURNISHED AND INSTALLED BY THE CONTRACTOR. ALL SURFACES TO RECEIVE WALLCOVERING SHALL RECEIVE A MINIMUM OF ONE COAT OF PRIMER/SEALER APPROPRIATE TO SUBSTRATE AND FINISH WALLCOVERING.

E. ALL CHANGES IN FLOOR MATERIAL AND COLORS SHALL OCCUR AT THE CENTERLINE OF DOORWAYS UNLESS NOTED OTHERWISE.

F. PAINT ALL UNFINISHED MATERIALS, GRILLES, REGISTERS, ETC. TO MATCH ADJACENT WALLS. MATERIALS WITH A NATURAL FINISH, SUCH AS ANODIZED ALUMINUM, SHALL BE LEFT IN THEIR NATURAL FINISH UNLESS OTHERWISE NOTED BY THE CONSTRUCTION DOCUMENTS.

G. SEE REFLECTED CEILING PLANS FOR CEILING FINISHES.

H. APPLY ONE PRIMER COAT AND TWO FINISH COATS ON SURFACES TO BE PAINTED.

I. PREPARE FLOOR FOR INSTALLATION OF FINISHES IN ACCORDANCE WITH THE MANUFACTURER'S SPECIFICATION AND RECOMMENDATIONS. REMOVE ALL FOREIGN MATTER, GREASE, WAX, PAINT, OIL, ADHESIVES, DIRT, ETC. CRACKS, HOLES AND DEPRESSIONS SHOULD BE FILLED WITH FLASHING COMPOUND OR LATEX PATCH MATERIAL. CUT OFF ANY PROTRUDING OBJECTS AND GRIND SMOOTH TO LEVEL WITH THE FLOOR SURFACE.

J. INSPECT FLOOR CONSTRUCTION AND SURFACES TO RECEIVE NEW FINISHES AND PROMPTLY NOTIFY THE ARCHITECT OF ANY DEFECTS IN THE SUBSTRATE THAT AFFECT THE WORK SO THAT THEY MAY BE CORRECTED BEFORE THE START OF THE WORK. PROCEEDING WITH THE WORK SHALL BE DEEMED AS ACCEPTANCE BY THE CONTRACTOR OF THE FLOOR AREAS AND HE SHALL BE RESPONSIBLE THEREAFTER FOR THE INSTALLATION OF THE WORK.

K. INSTALL FLOORING MATERIALS WITHIN THE ALLOWABLE TEMPERATURE RANGE AS STATED BY THE MANUFACTURER'S INSTALLATION INSTRUCTIONS. ALL FLOORING MATERIAL SHALL BE DELIVERED TO THE SITE IN TIME TO ACCLIMATE TO CONDITIONS PRIOR TO INSTALLATION. SUBMIT A COPY OF THE INSTALLATION INSTRUCTIONS SHALL BE SUBMITTED TO THE ARCHITECT AND THE OWNER.

UNLESS NOTED OTHERWISE, PAINT ALL EXISTING AND NEW PARTITIONS, BULKHEADS AND OTHER CONSTRUCTS WITHIN THE PROJECT AREA COLOR NO. P-1. SEE FINISH SCHEDULE.

M. ALL RESTROOM WALL TO RECEIVE CT-4 AND CT-5 TILE. FLOOR TO CEILING. REFER TO ELEVATIONS FOR PATTERN AND STARTING POINT.

N. ALL PRIVATE OFFICES WITH EXTERIOR WINDOWS TO GET DRAPERY FABRIC F-1.

P. ALL DRYWALL CEILING TO BE PAINTED P-3.

AF-01 EXISTING FINISHES TO REMAIN, REPAIR AND REPLACE AS REQUIRED.

AF-03 FLOOR TILE STARTING POINT.

AF-01 EXISTING FINISHES TO REMAIN, REPAIR AND REPLACE AS REQUIRED.

AF-03 FLOOR TILE STARTING POINT.

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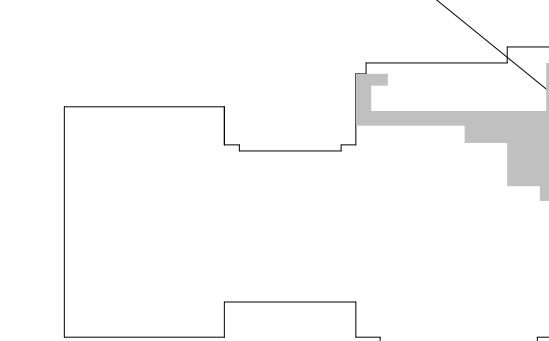
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SEALS AND SIGNATURES

KEYPLAN



PROJECT ARE



	SHEET TITLE
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FURNITURE PLAN - FOR
REFERENCE ONLY

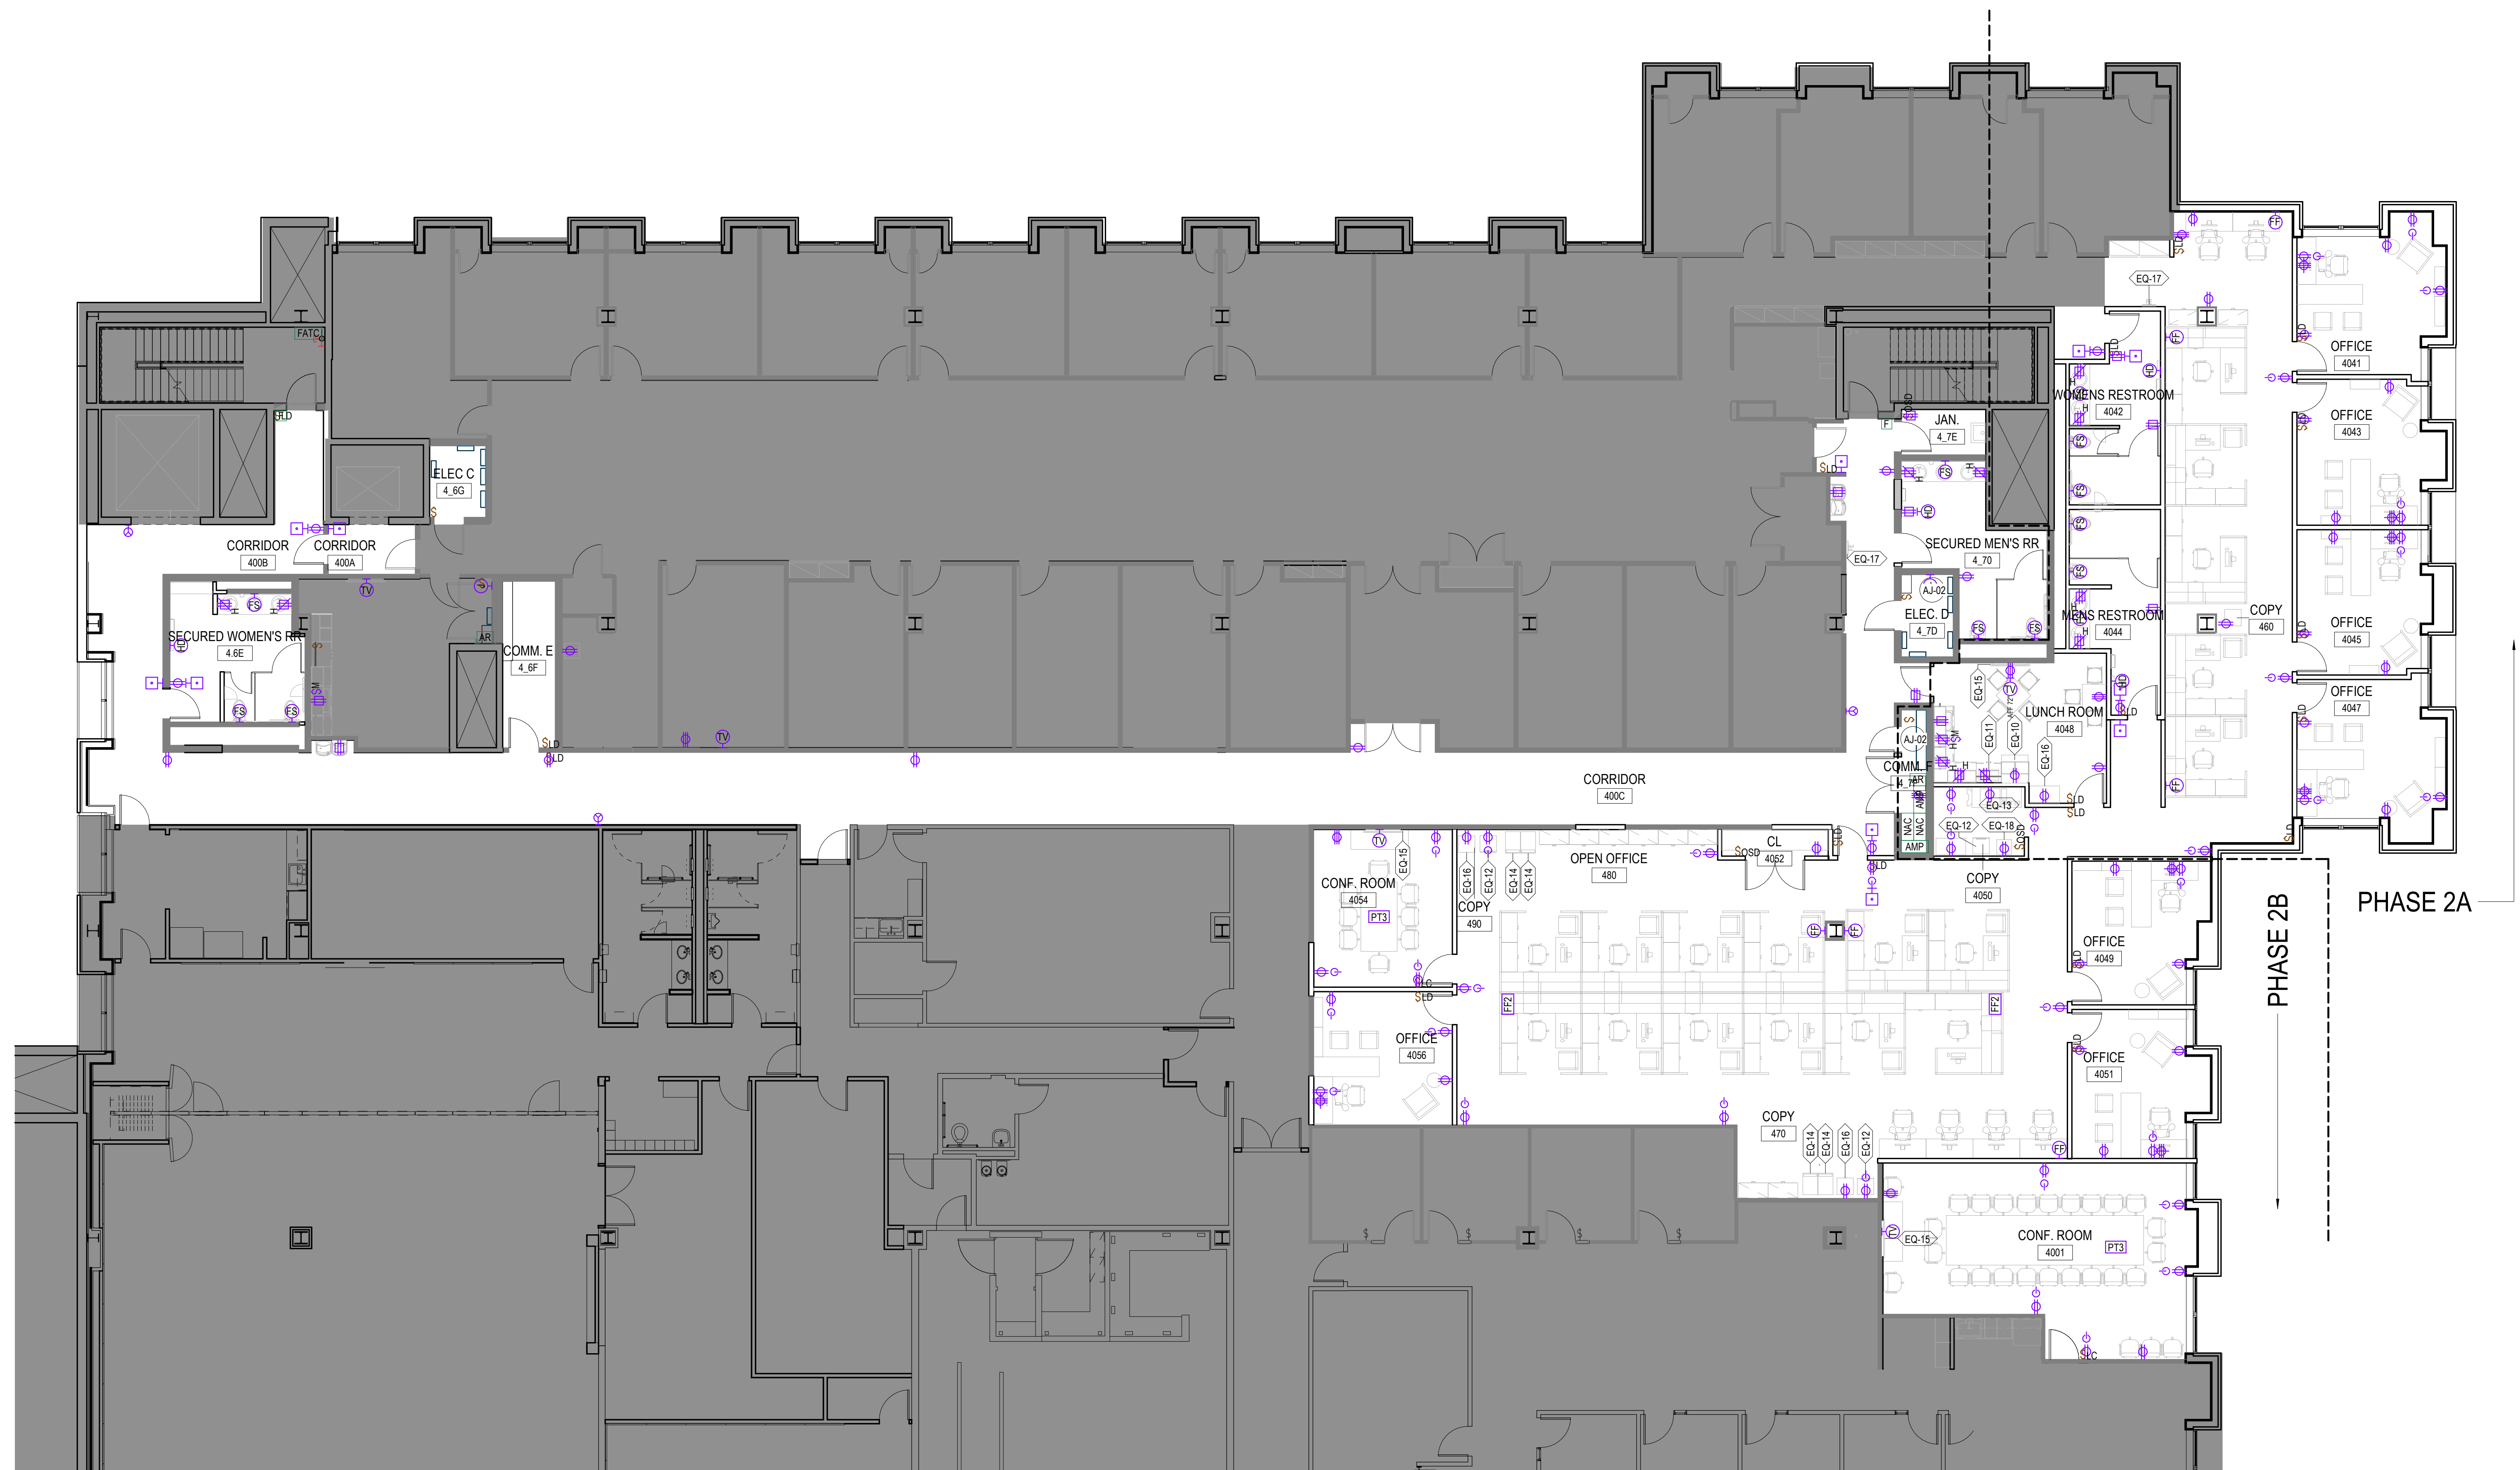
PROJECT NUMBER

12808



2.A1.504

SHEET NUMBER



1 POWER/SIGNAL COORDINATION PLAN
- FOURTH FLOOR 2
SCALE: 1/8" = 1'-0"

GRAPHIC LEGEND

EQUIPMENT AND ACCESSORY SCHEDULE 1					
TYPE MARK	MANUFACTURER	DESCRIPTION	MODEL	FINISH/MATERIAL	COMMENTS
EQ-10	WHIRLPOOL	REFRIGERATOR	WRT5415ZDW	WHITE	ICE MAKER BOX OATEY 39140 TO BE INCLUDED
EQ-11	WHIRLPOOL	MICROWAVE	WMC30516HW	WHITE	
EQ-12	VENDOR SUPPLIED	BIN SHREDDER	NA		
EQ-13	VENDOR SUPPLIED	COPY/PRINTER			
EQ-14	OWNER SUPPLIED	CART			
EQ-15	VENDOR SUPPLIED	TV			REFER TO AV DRAWINGS
EQ-16	ARCOMAS	TRASH RECEPTACLE	TEMPTATIONS SERIES, A-800 FF3		
EQ-17	EXISTING	FIRE EXTINGUISHER			

GENERAL SHEET NOTES

- | | | |
|--|---|---|
| <p>A. REFER TO THE A0 1 SERIES SHEETS FOR ARCHITECTURAL GENERAL NOTES, DRAWING, REFERENCE AND MATERIAL SYMBOLS, ABBREVIATIONS, AS WELL AS DIMENSIONING CONVENTIONS USED ON THIS SHEET</p> | <p>E. INSTALL ALL WALL MOUNTED PUTD DEVICES VERTICALLY AT 18" A.F.F. TO CENTERLINE UNLESS NOTED OTHERWISE ON THE PLANS.</p> | <p>I. WHERE CORE DRILLING IS REQUIRED, XRAY THE CONCRETE SLAB TO VERIFY THAT THE LOCATION TO BE DRILLED IS FREE OF OBSTRUCTIONS. REPORT FINDINGS OF THE XRAY TO THE OWNER PRIOR TO COMMENCING THE WORK.</p> |
| <p>B. THE PURPOSE OF THE DRAWINGS ON THIS SHEET IS TO DEFINE THE LOCATION OF ELECTRICAL, TELEPHONE, DATA, AND SECURITY DEVICES, OUTLETS, SWITCHES, AND CONNECTION POINTS FOR COORDINATION WITH FURNITURE AND INTERIOR DESIGN REQUIREMENTS.</p> | <p>F. ELECTRICAL WORK AND MATERIALS SHALL BE IN COMPLIANCE WITH NATIONAL ELECTRICAL CODE AND ALL OTHER RELATED CODES IN USE BY THE GOVERNING GOVERNMENT AGENCY(ES) AT THE TIME OF CONSTRUCTION. IN THE EVENT OF A CONFLICT BETWEEN THE AFOREMENTIONED REQUIREMENTS, THE MORE RESTRICTIVE SHALL APPLY.</p> | <p>J. COORDINATE WITH ELECTRICAL DRAWINGS FOR MORE INFO.</p> |
| <p>C. REFER TO AND COORDINATE WITH MECHANICAL, PLUMBING, AND ELECTRICAL FOR ADDITIONAL INFORMATION NOT SHOWN ON THIS SHEET.</p> | <p>G. ALL MOUNTING HEIGHTS INDICATED ARE TO THE CENTERLINE(S) OF OUTLET(S), DEVICE(S) OR EQUIPMENT UNLESS NOTED OTHERWISE.</p> | |
| <p>D. REFER TO THE A0 1 SERIES SHEETS FOR TYPICAL MOUNTING HEIGHTS FOR DIMENSIONS NOT SHOWN ON THIS SHEET.</p> | <p>H. OUTLETS, OR OTHER DEVICES, WHICH ARE MOUNTED ON OPPOSITE SIDES OF PARTITIONS SHALL NOT BE MOUNTED BACK TO BACK.</p> | |

SHEET KEYNOTES

- AJ-02 COORDINATE WITH ENGINEERING DRAWINGS AND SPECS.

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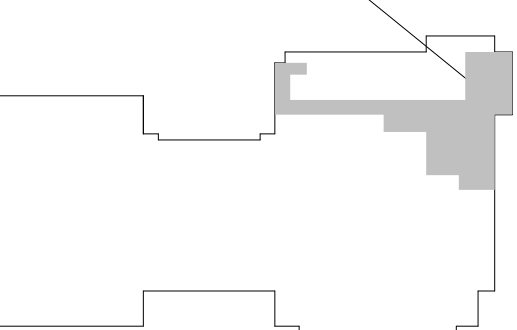
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SEALS AND SIGNATURES

KEYPLAN



PROJECT AREA _____



SHEET TITLE

POWER/SIGNAL
COORDINATION PLAN -
FOURTH FLOOR

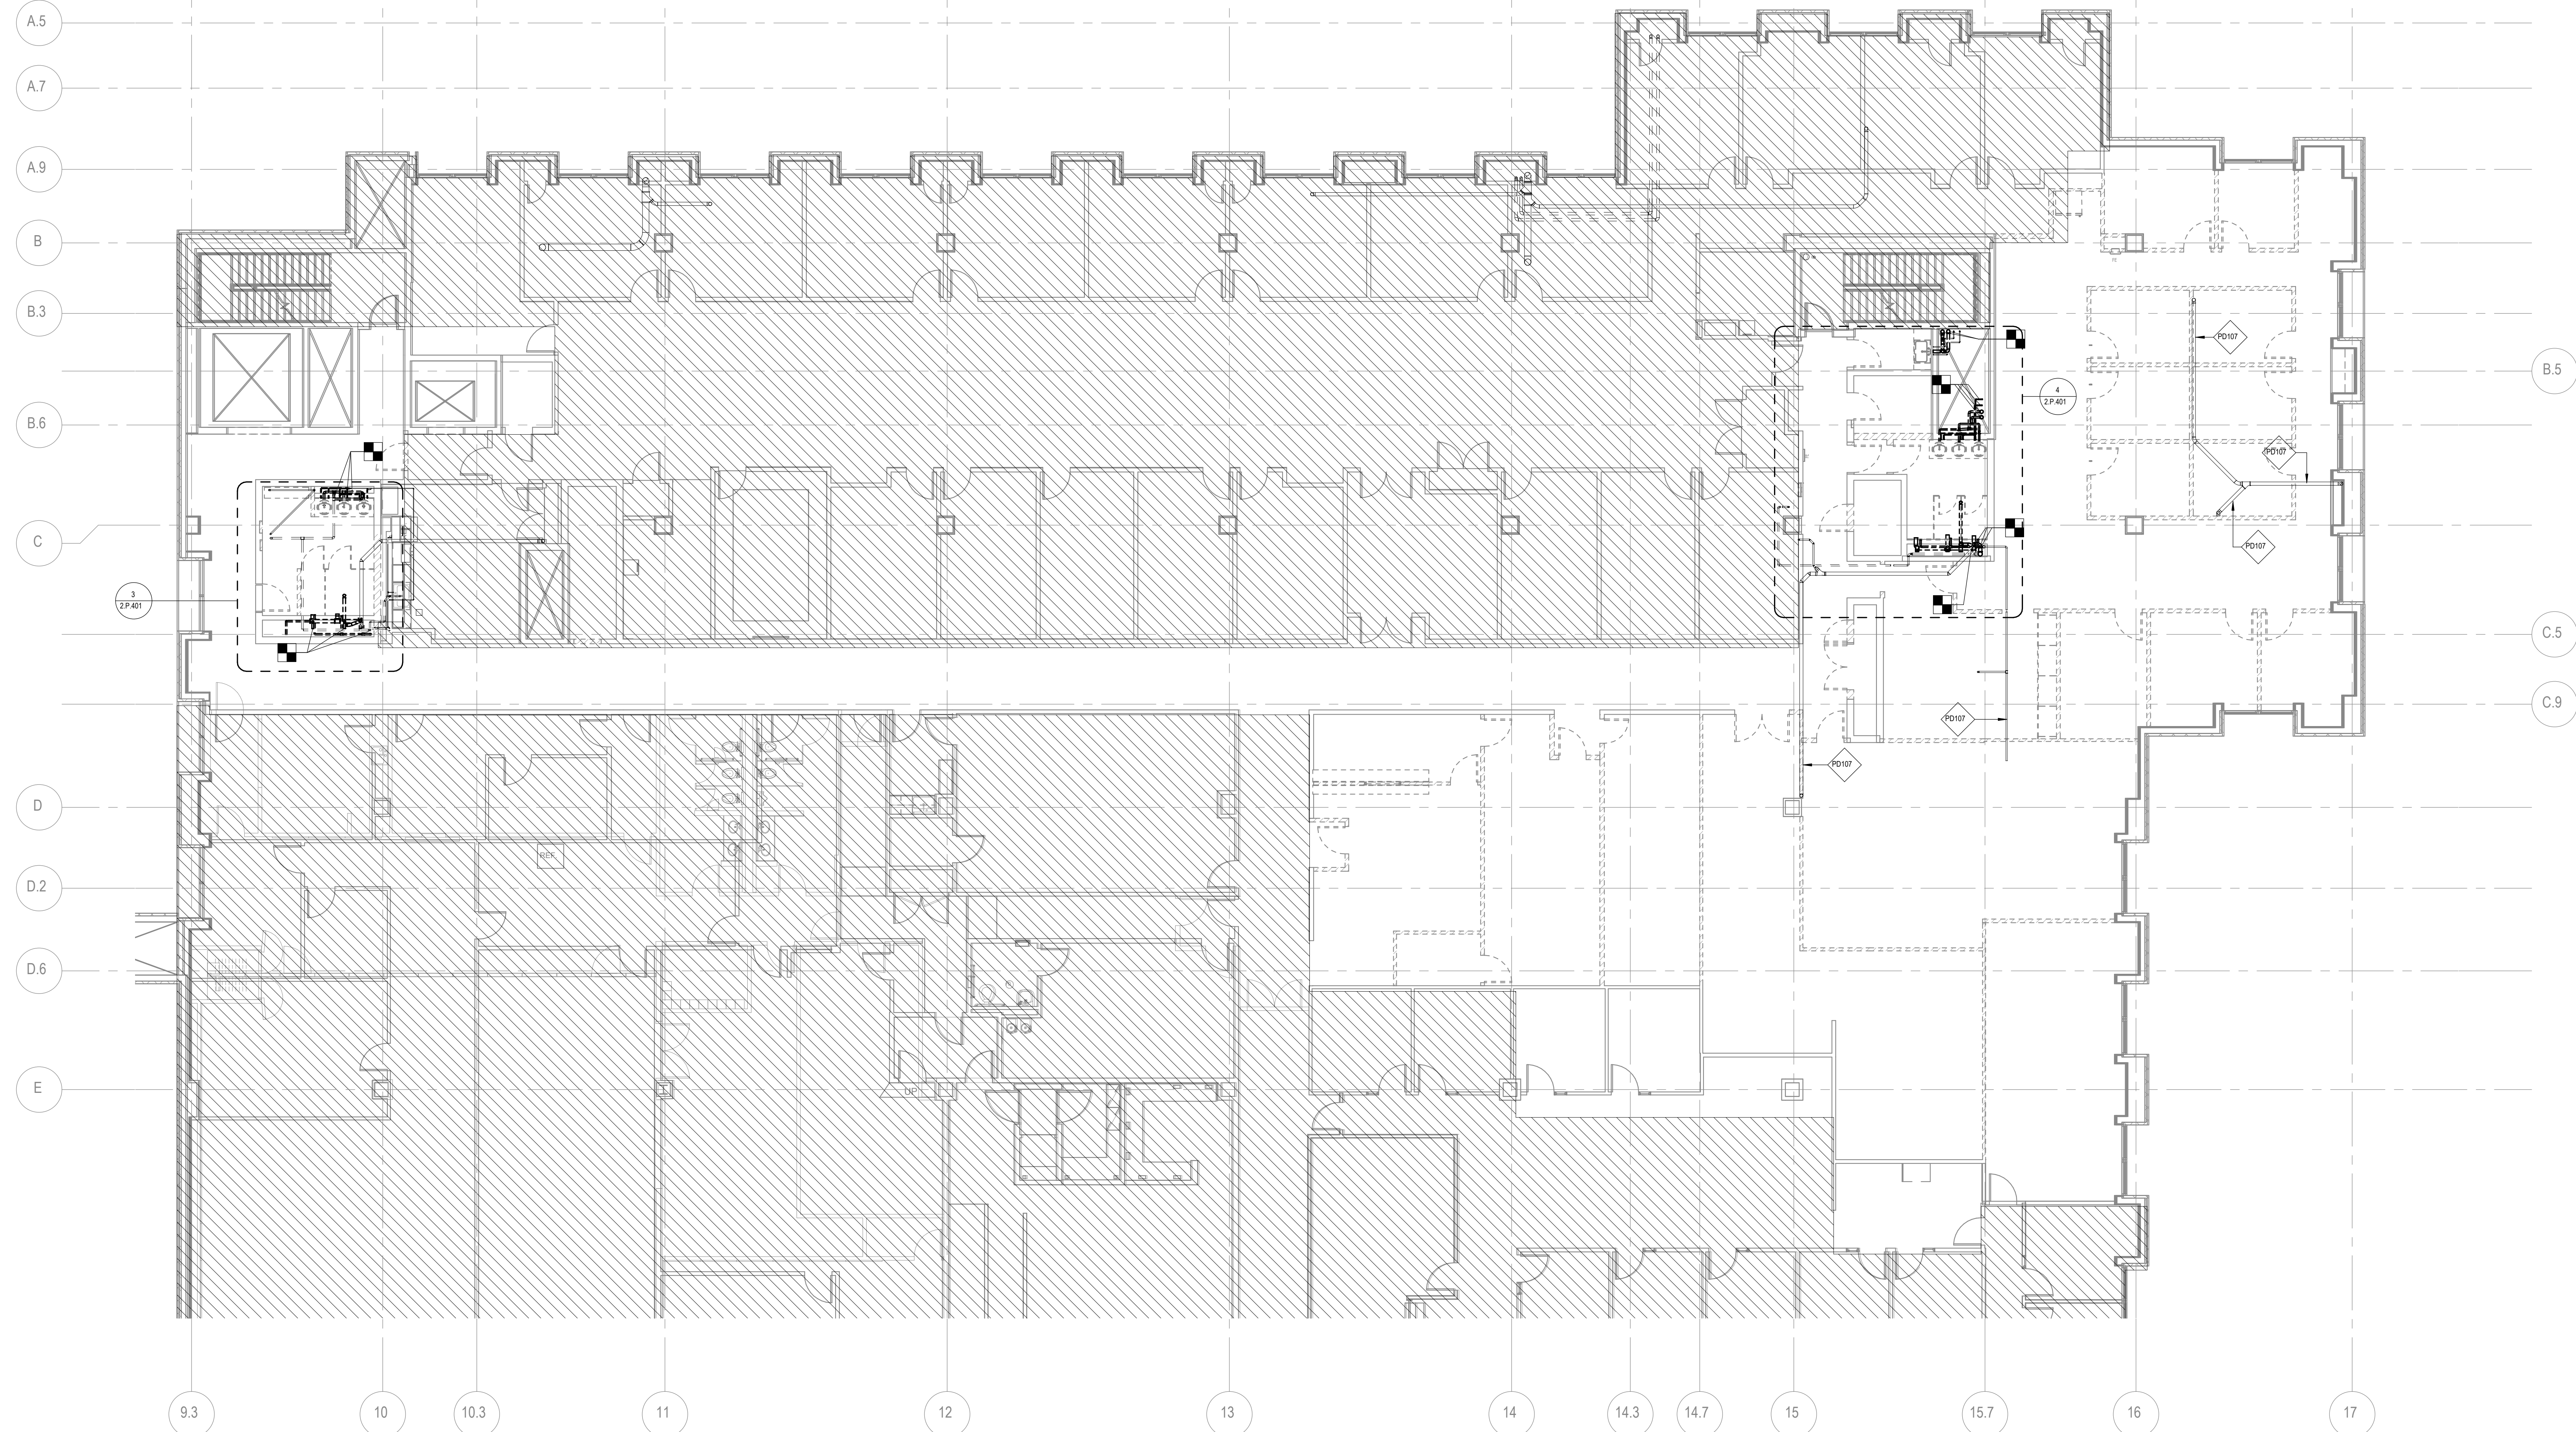
PROJECT NUMBER



2.AJ.604

SHEET NUMBER

12808



CMC FOURTH FLOOR EAST SECURE
SUPPORT SPACES RENOVATION
(PHASE 2A AND 2B)
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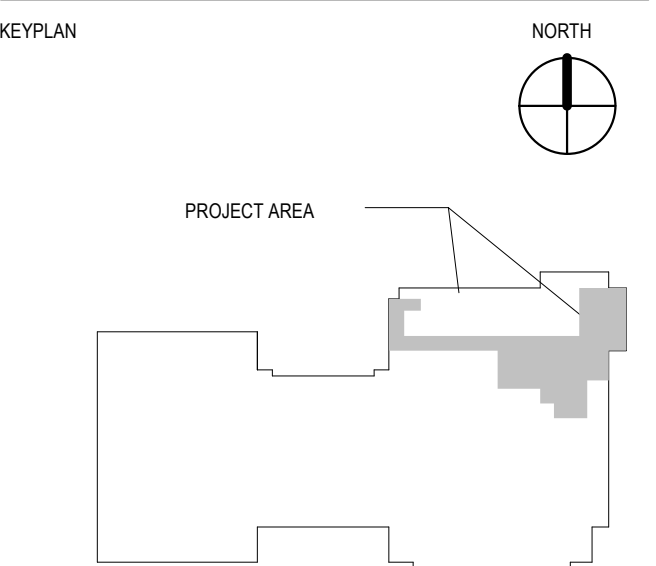
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SEALS AND SIGNATURES



GENERAL SHEET NOTES

- A. SEE DRAWING P001 FOR SYMBOLS, ABBREVIATIONS AND GENERAL NOTES.
- B. HORIZONTAL DRAINAGE PIPING SHALL BE INSTALLED IN UNIFORM ALIGNMENT AT UNIFORM SLOPES. THE SLOPE OF A HORIZONTAL DRAINAGE PIPE SHALL BE NOT LESS THAN THAT INDICATED IN TABLE 704.1 OF 1981 INTERNATIONAL PLUMBING CODE.
- C. ALL FLOOR DRAINS ARE REQUIRED TO HAVE TRAP PRIMERS.
- D. PLASTIC SANITARY AND VENT PIPE SHALL NOT BE USED ABOVE GRADE.
- E. ALL HORIZONTAL DRAINS SHALL BE PROVIDED WITH CLEANOUTS LOCATED NOT MORE THAN 100 FEET APART

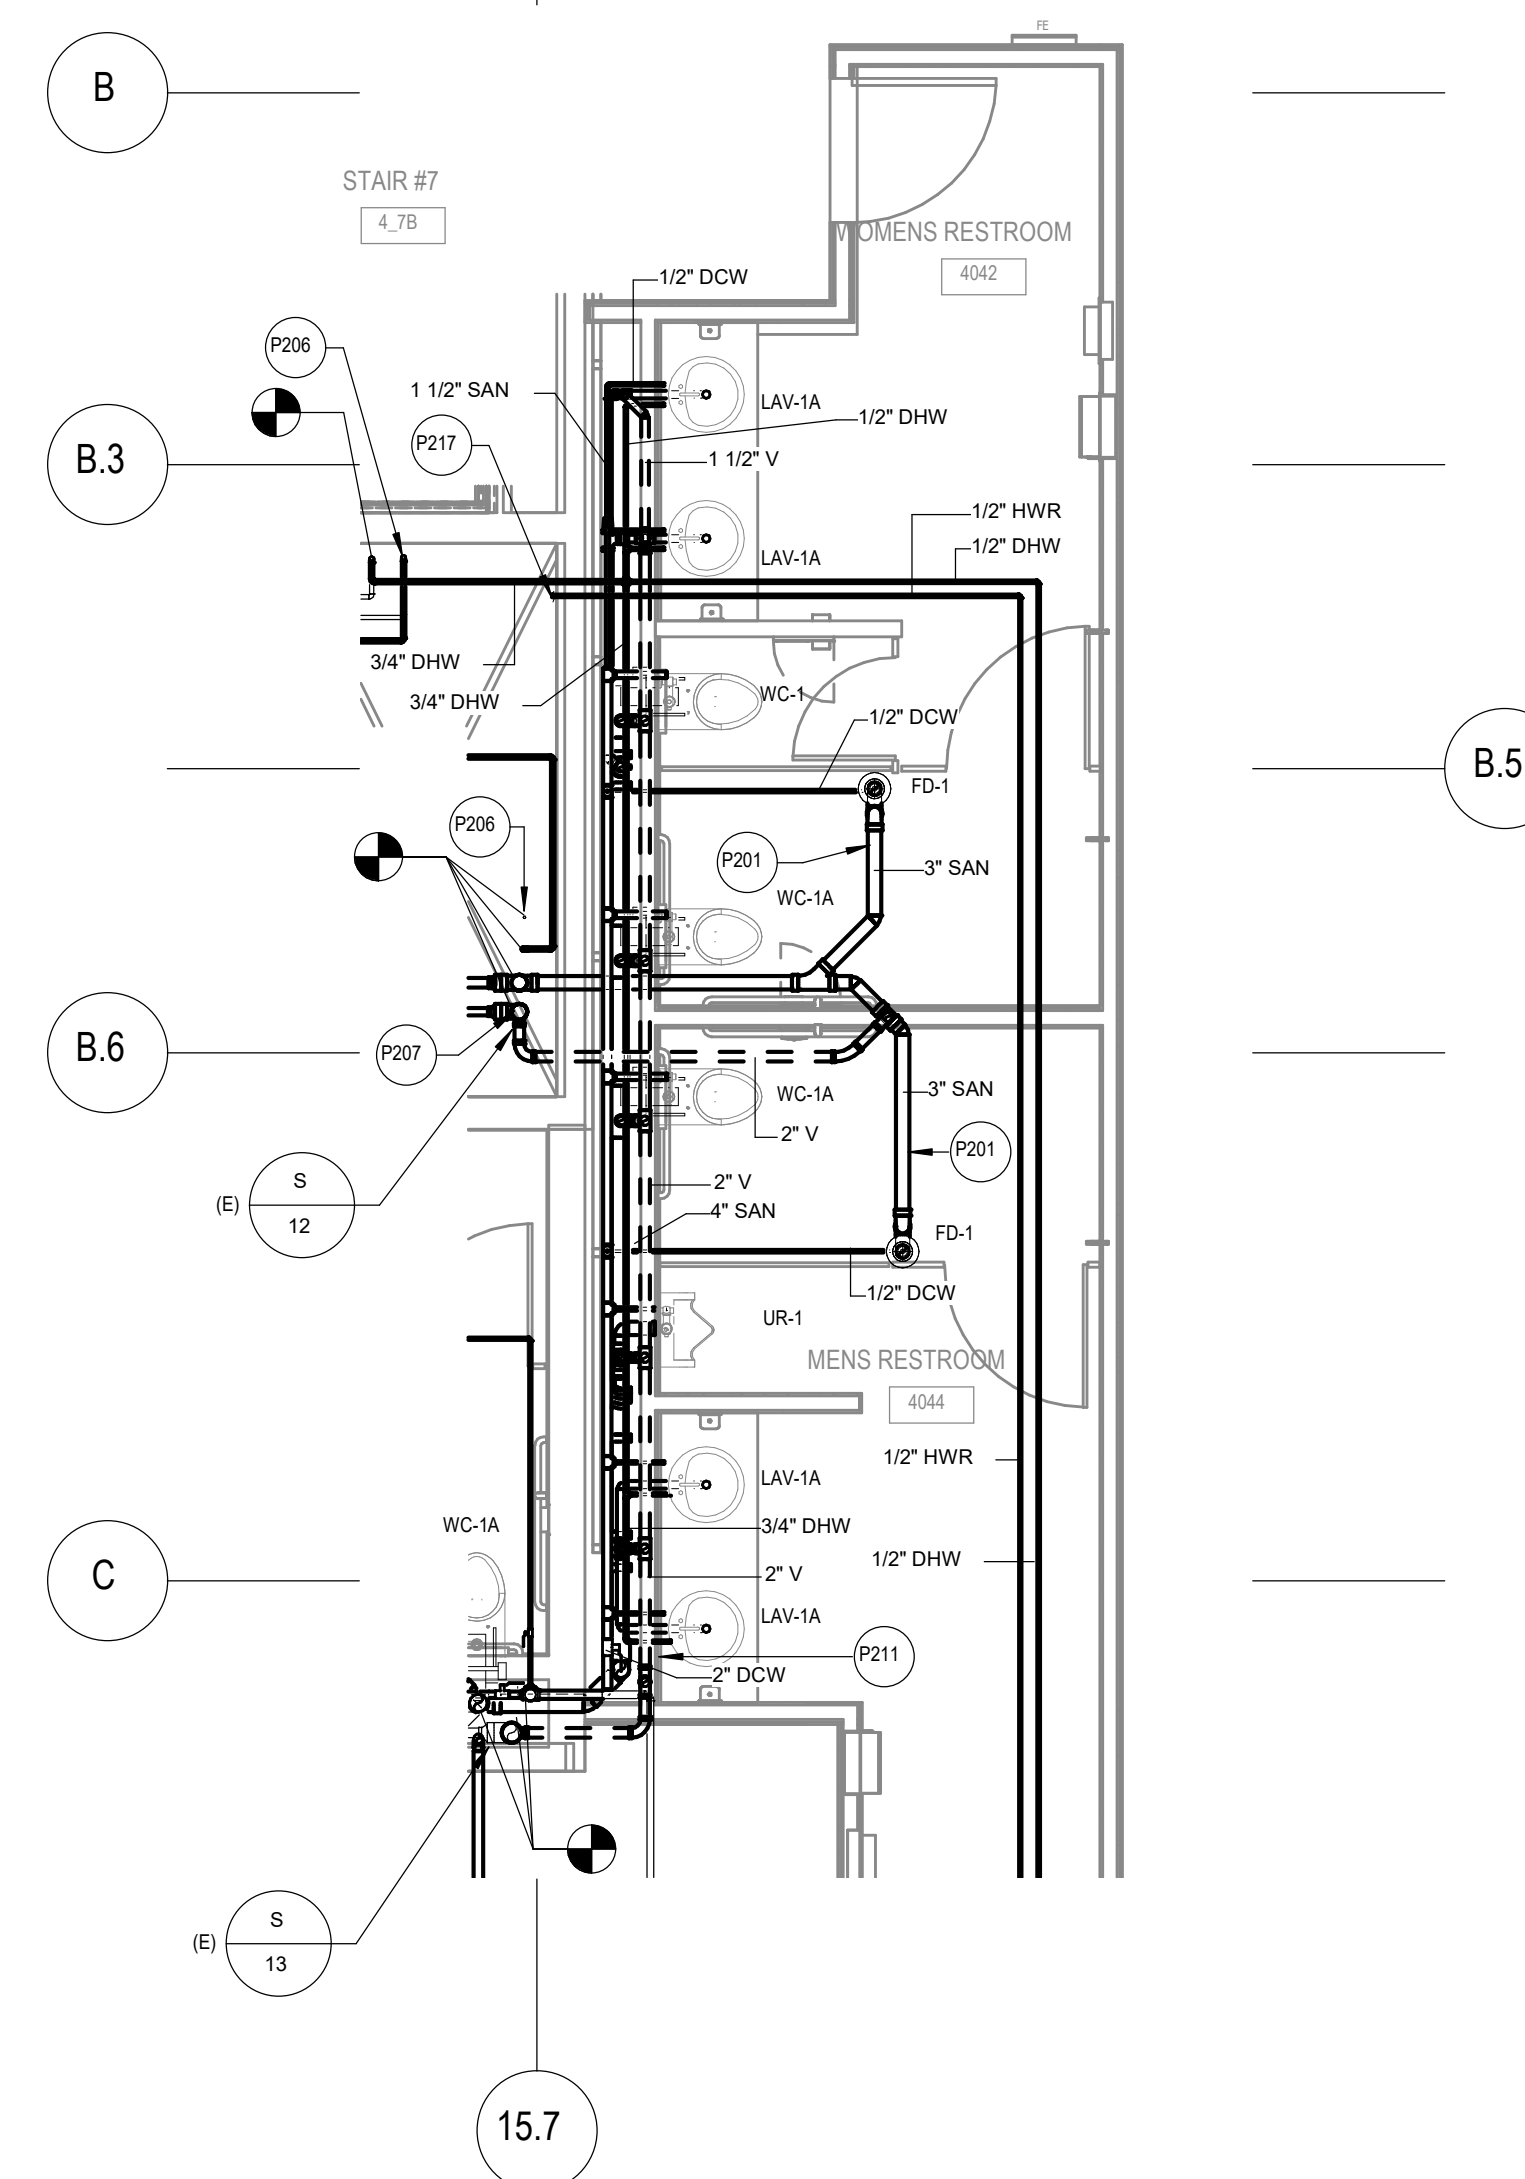
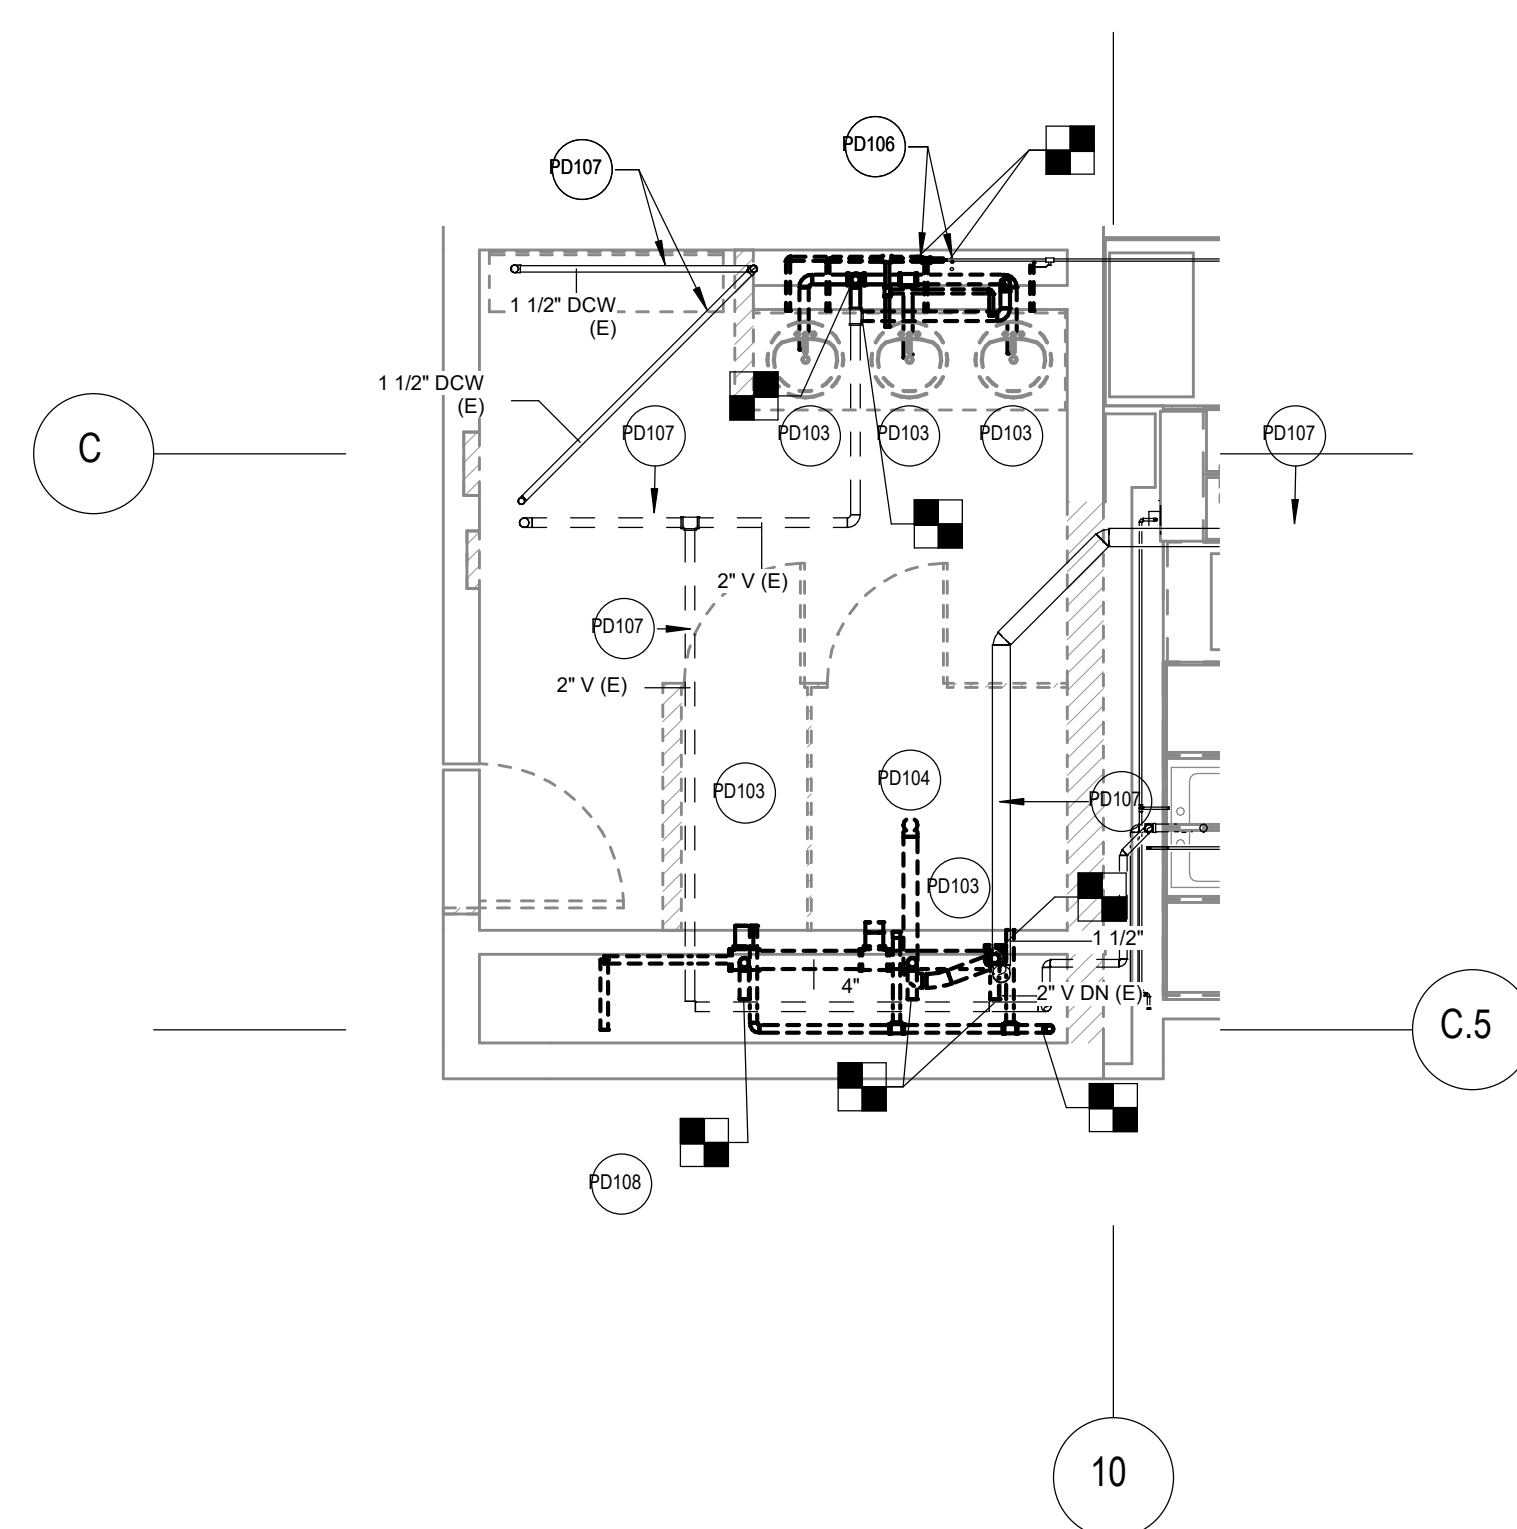
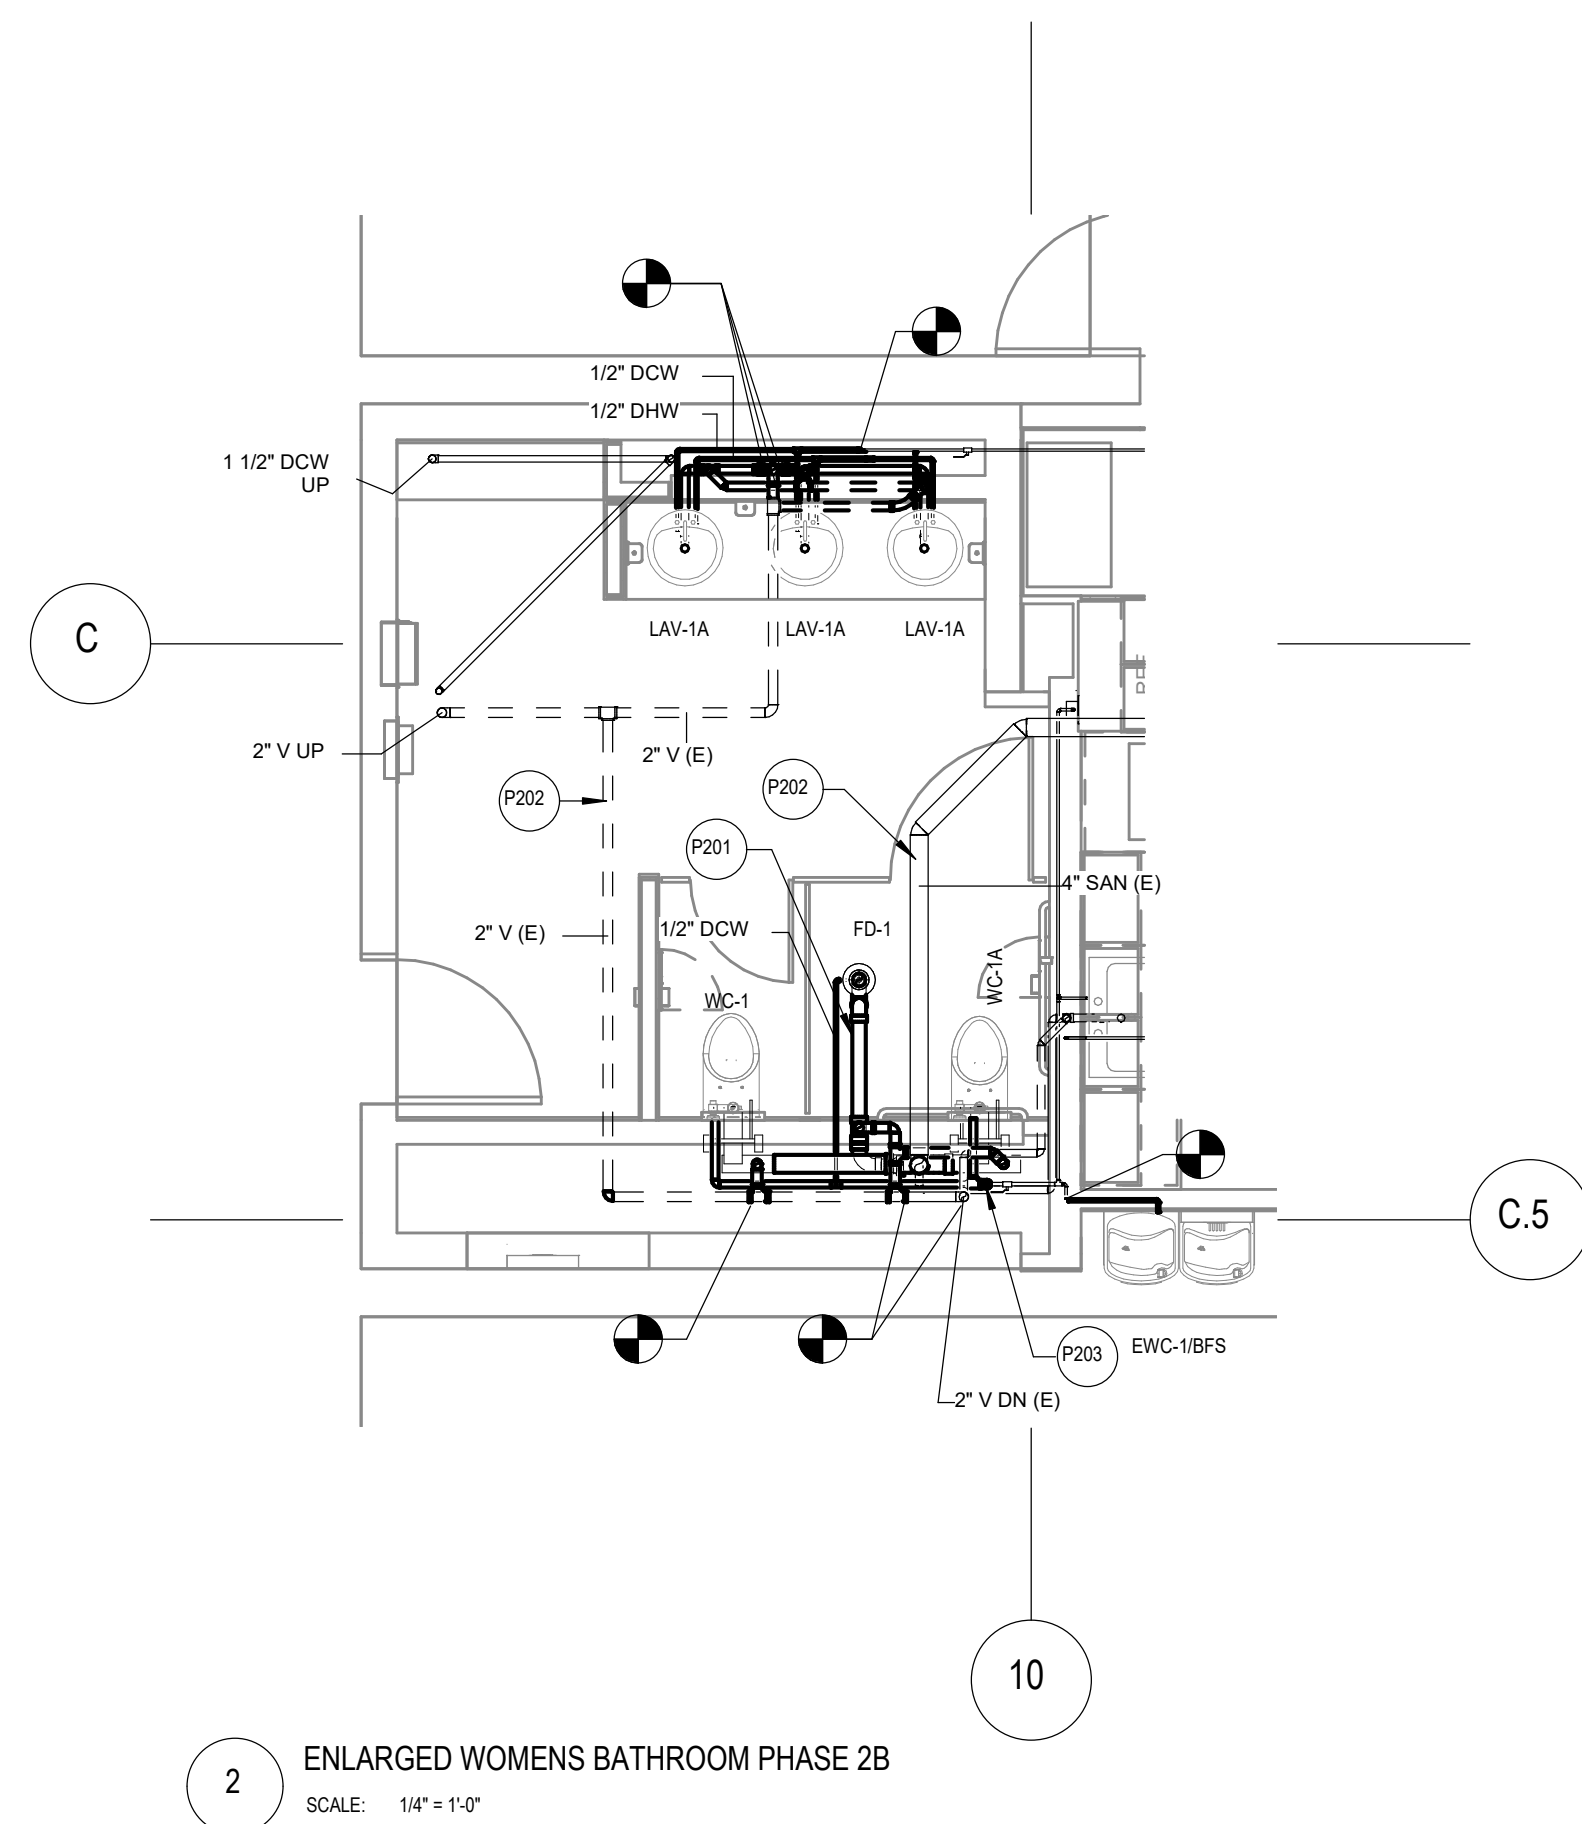
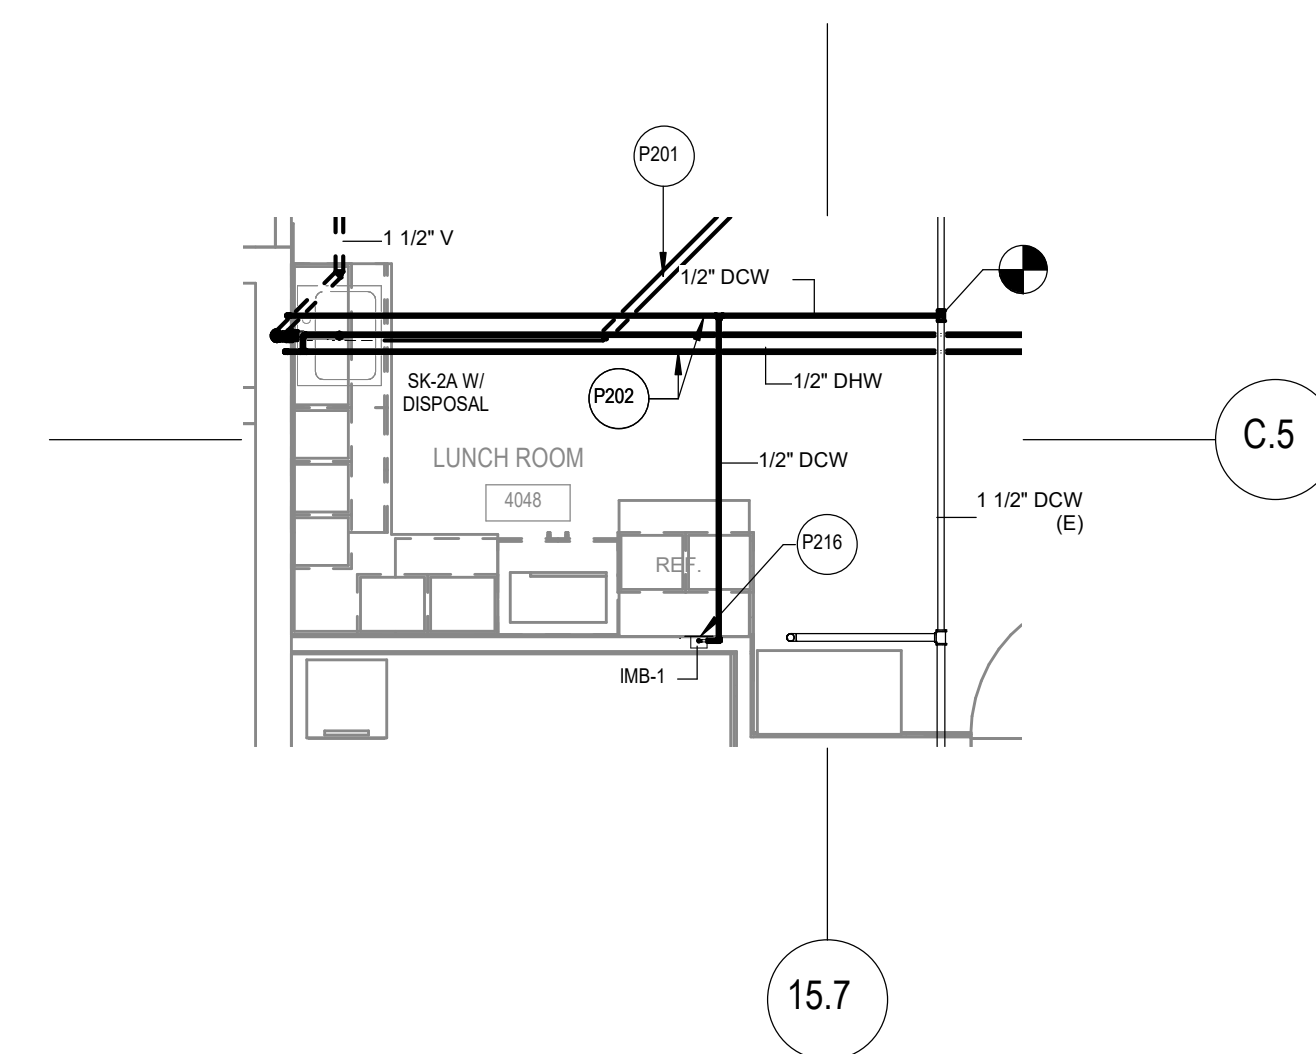
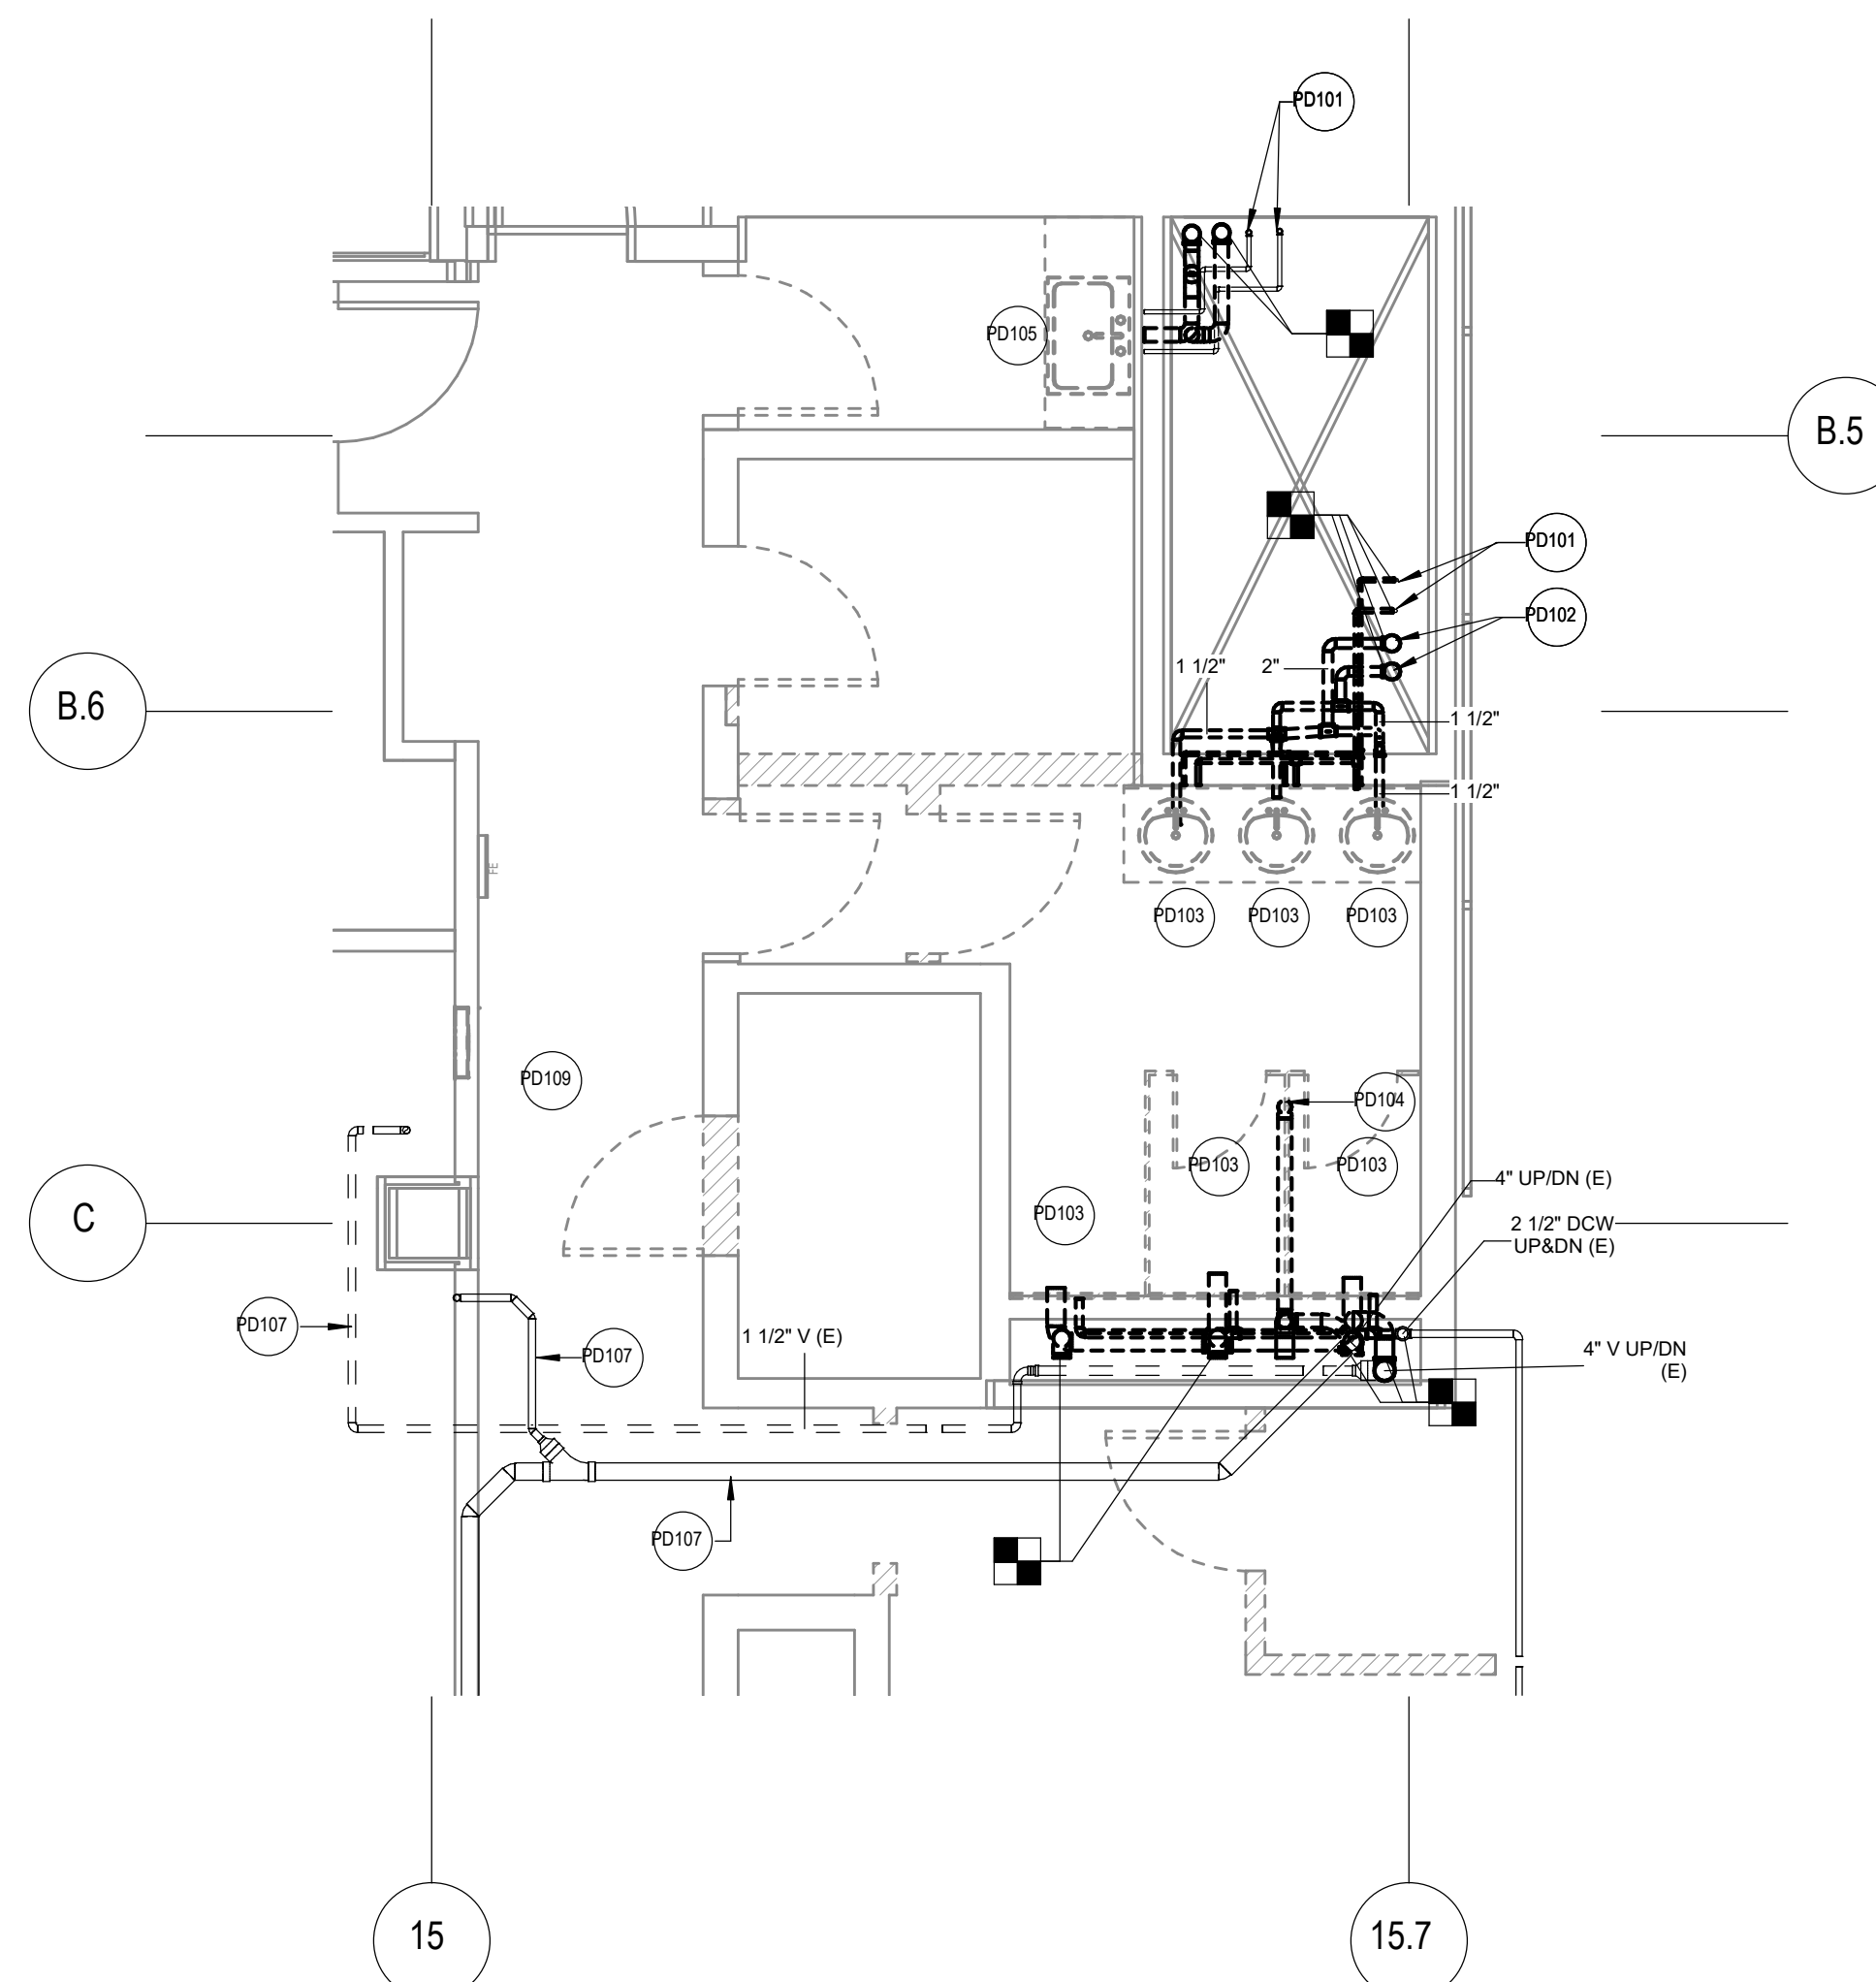
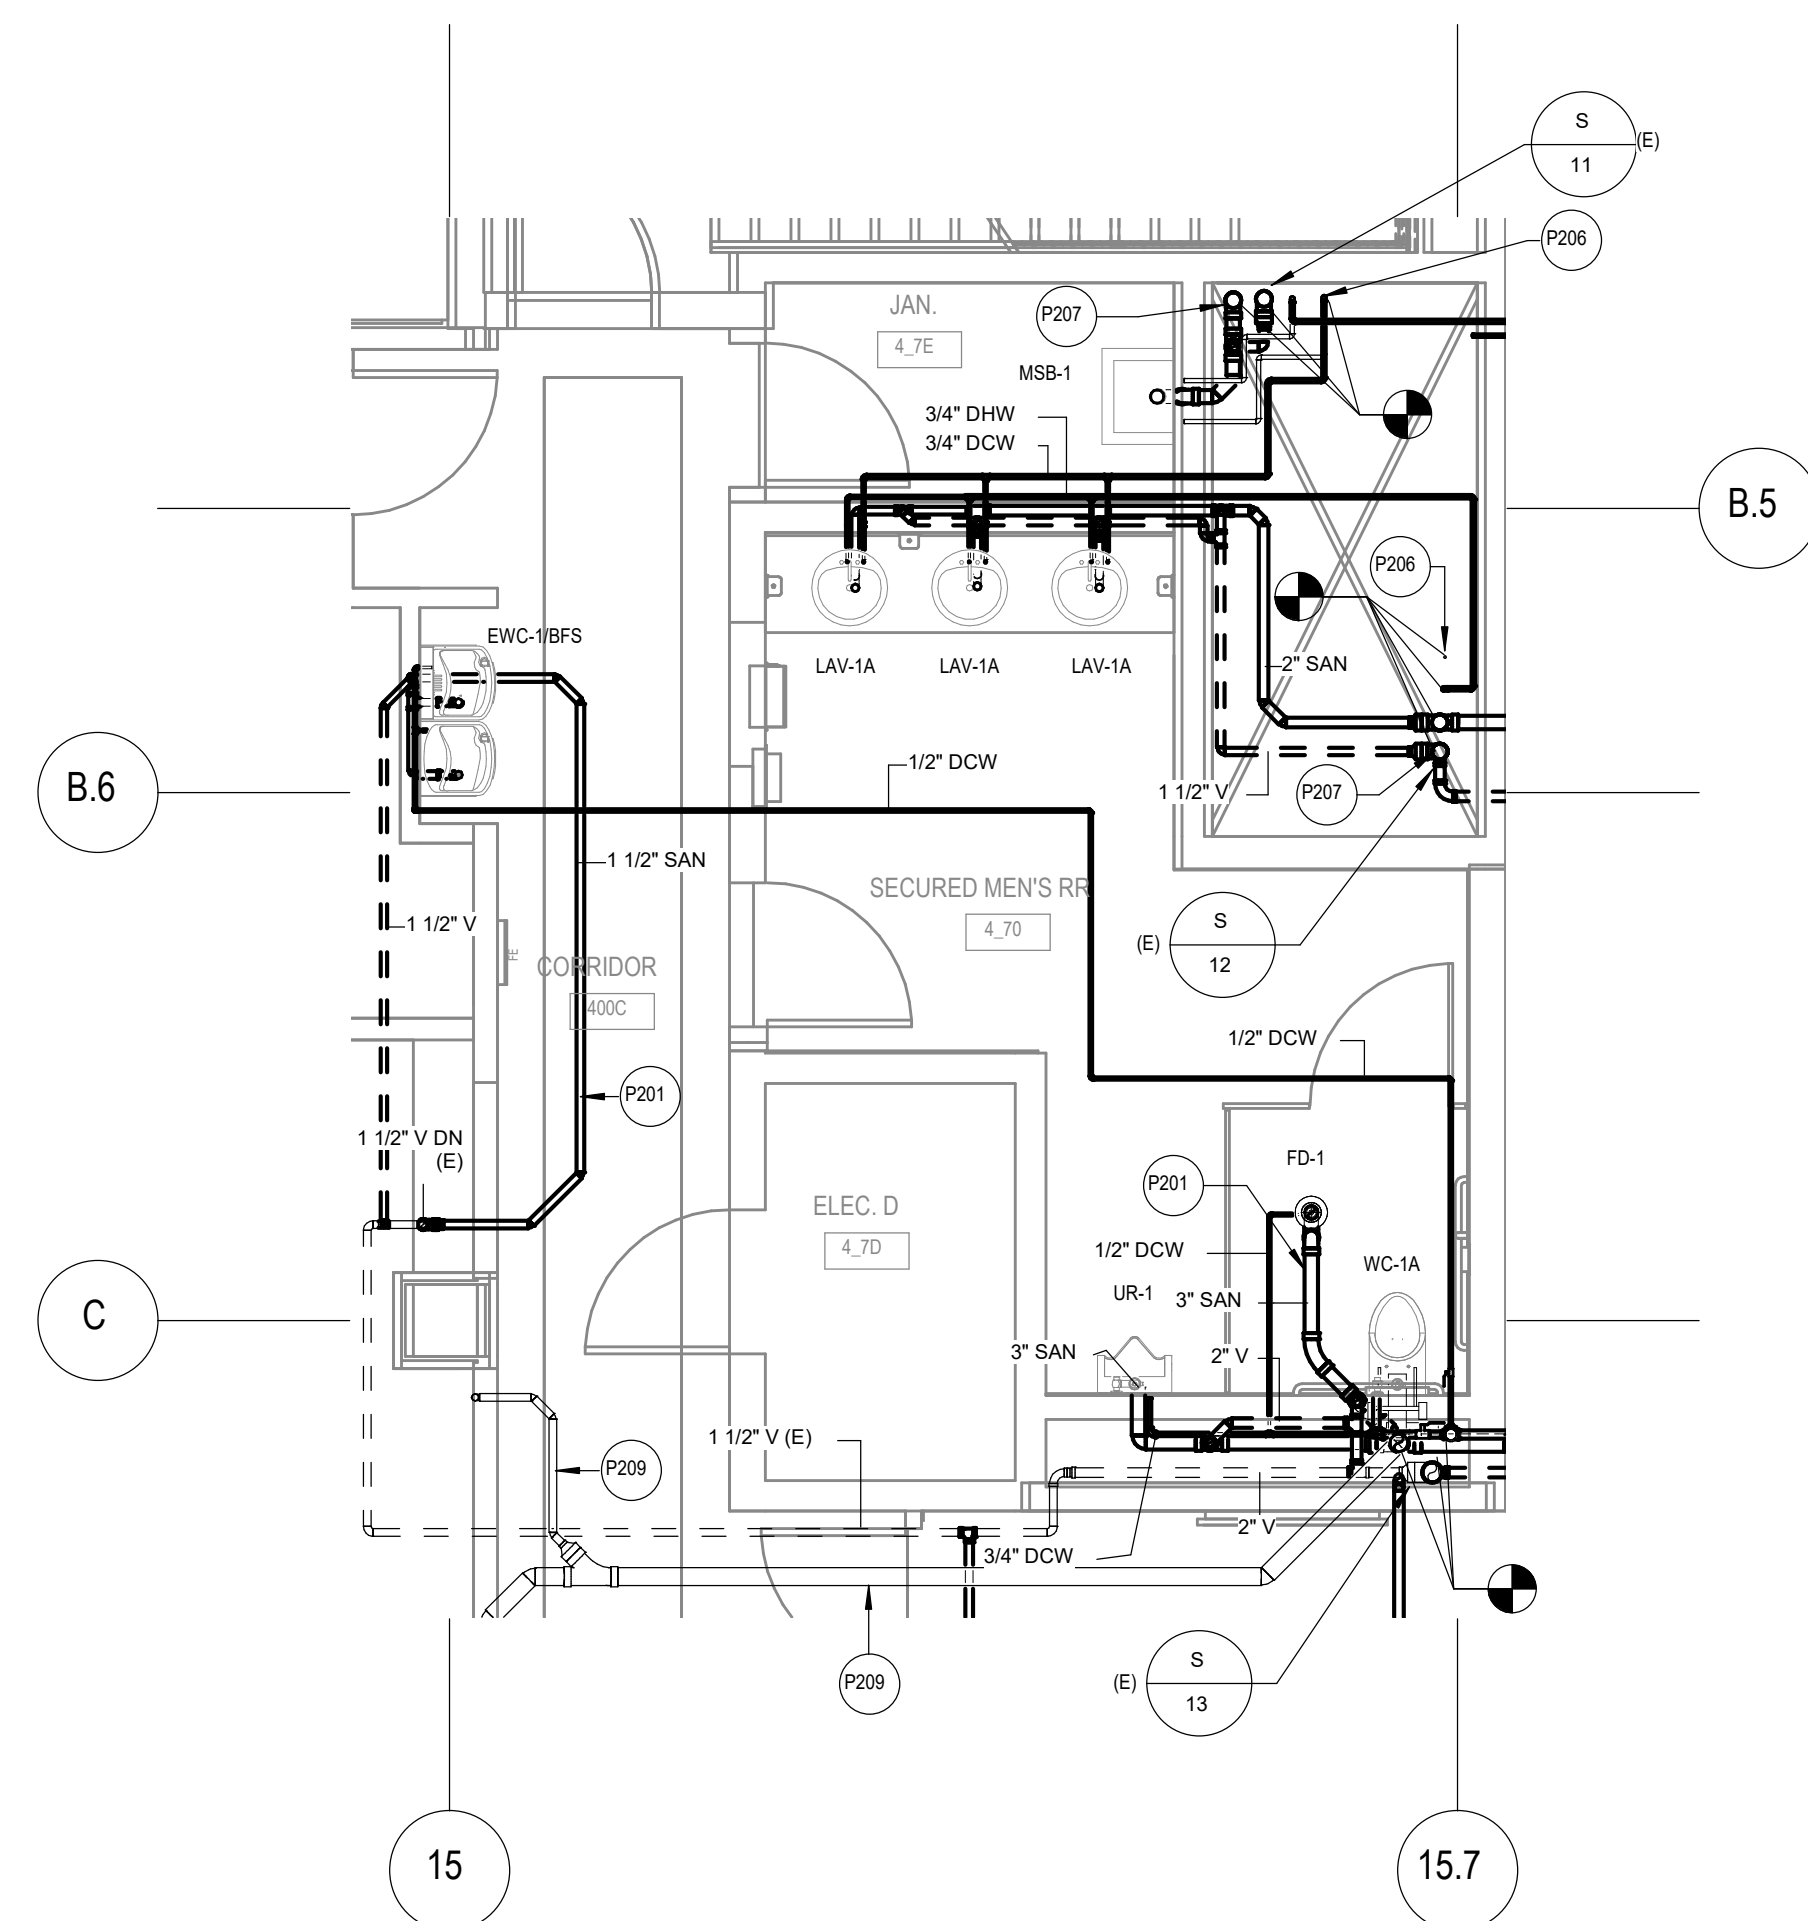
○ SHEET KEYNOTES

PD107 (E) PIPE TO REMAIN.

SHEET TITLE

FOURTH LEVEL PLUMBING
DEMOLITION PLAN

PROJECT NUMBER
CD 2.PD.204
 SHEET NUMBER






PROJECT NUMBER	Project Number
CD	2.P.501
SHEET NUMBER	



M210	CONNECT NEW 10"X10" MAIN EXHAUST DUCTWORK TO SHAFT.
M211	CONNECT EXISTING 22"X8" SUPPLY DUCTWORK TO NEW 24"X8" SUPPLY DUCTWORK.
M212	CONNECT NEW 12"X8" MAIN EXHAUST DUCTWORK TO SHAFT. KEEP AREA OUT OF SCOPE SERVED BY MAIN OPERATIONAL, ANY NECESSARY SHUTDOWN TO BE COORDINATED WITH DC COURTS.
M213	CONNECT EXISTING 34"X14" SUPPLY DUCTWORK TO NEW 24"X12" SUPPLY DUCTWORK.
M214	CONNECT NEW 24"X12" EXHAUST DUCTWORK WITH NEW 10"X8" EXHAUST BRANCH TO 24"X12" EXHAUST DUCTWORK IN PHASE 2B. ANY NECESSARY SHUTDOWN TO BE COORDINATED WITH DC COURTS.
M215	CONNECT NEW 40"X12" RETURN DUCTWORK TO EXISTING 42"X12" RETURN DUCTWORK.
M216	CONNECT NEW 6" SUPPLY DUCTWORK TO EXISTING VAV-415.
M217	CONNECT NEW 30"X14" SUPPLY DUCTWORK TO EXISTING 20"X10" SUPPLY DUCTWORK.
M218	CONNECT NEW 24"X6" RETURN DUCTWORK TO EXISTING 24"X6" RETURN DUCTWORK.
M219	CONNECT NEW 32"X10" RETURN DUCTWORK TO EXISTING 32"X8" RETURN DUCTWORK.
M220	CONNECT EXISTING 18"X6" SUPPLY DUCTWORK TO NEW 12"X6" SUPPLY DUCTWORK.
M221	OPEN END DUCT WITH WIRE MESH SCREEN.
M222	

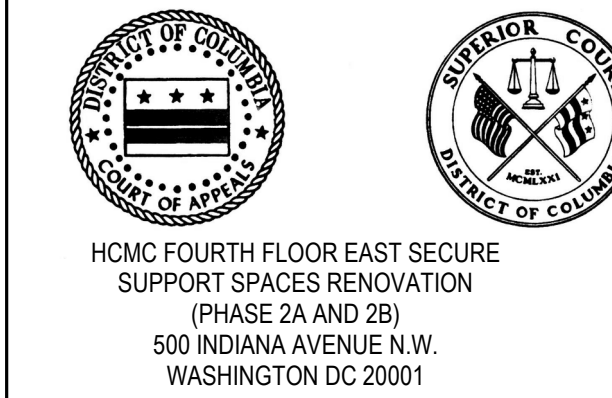

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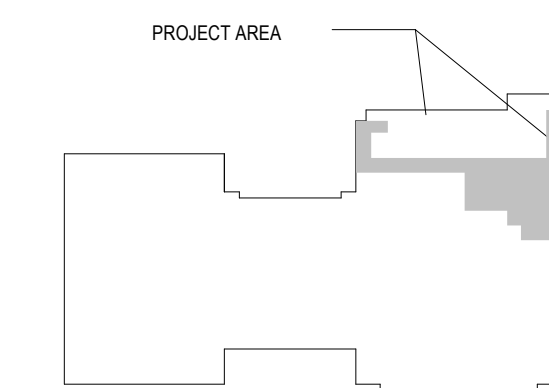
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SEALS AND SIGNATURES

KEYPLAN



PROJECT AREA



8. REFER TO SHEET M007 FOR MECHANICAL ABBREVIATIONS, SYMBOLS, AND GENERAL NOTES.

9. THE EXISTING CONDITIONS INDICATED ARE BASED ON THE ORIGINAL DESIGN DRAWINGS AND A SITE SURVEY. SIGHT VARIATIONS IN ACTUAL INSTALLATION MAY BE ENCOUNTERED DURING CONSTRUCTION. THE CONTRACTOR SHALL BE RESPONSIBLE FOR IDENTIFYING AND CORRECTING ANY UNAPPROVED SEASIDE AND BEACH EROSION OR SEASIDE LEAKAGE. OCEAN

10. CONTRACTOR SHALL VERIFY PROPER OPERATION OF ALL EXISTING EQUIPMENT IN AREA AFFECTED BY THIS WORK FROM CONSTRUCTION. WHENEVER DEFICIENCIES OCCUR, CONTRACTOR SHALL IMMEDIATELY NOTIFY THE BUILDING OWNER.

11. CONTRACTOR SHALL BE RESPONSIBLE FOR ALL AIR HANDLING UNITS SERVING AREA UNDER CONSTRUCTION. REMOVE ALL FILTERS AS REQUIRED DURING THE COMPLETION OF WORK. AT THE END OF CONSTRUCTION, CONTRACTOR SHALL REMOVE ALL PRE-FILTER MEDIA AND REPLACE ANY PERMANENT FILTER WITH NEW, CLEAN, FRESH MEDIA.

12. CLEAN ALL AIRWAYS FROM DUCTWORK.

13. PROVIDE BOMBABLE CABLE REMOTE CONTROL OPERATION FOR ANY DIFFUSER THAT HAS AN ACCESSIBLE MANUAL ADJUSTMENT SHAFT. LOCATED IN CEILING PLenum AND BE ACCESSIBLE FROM LOCAL ACCESS.

14. PROVIDE NEW FLEXIBLE DUCTWORK FOR ALL RELOCATED OR SUPPLEMENTARY SUPPLY AIR DEVICES.

15. PROVIDE VOLUME DAMPERS FOR ALL NEW TUNNELS.

16. PRIOR TO COMPLETION ANY CLEANING OF NEW WORK, PERFORM COMPLETE TESTING AND AIR BALANCING WORK ON ASSIGNED SYSTEMS.

M301	3/4" HEATING HOT WATER PIPING UP TYPICAL THROUGHOUT.
M302	PROVIDE AND CONNECT NEW FIBER PIPERADIATOR AND ACCESSORIES. SEE DETAIL FOR ADDITIONAL INFORMATION. EXISTING COVERS TO REMAIN, COORDINATE WITH ARCHITECTURAL DRAWINGS.
M307	CONNECT NEW 3/4" HEATING HOT WATER PIPING TO EXISTING 3/4" HEATING HOT WATER PIPING.
M308	CONNECT NEW VAV-430 TO EXISTING 3/4" HEATING HOT WATER PIPING.
M309	CONNECT NEW VAV-429 TO EXISTING 3/4" HEATING HOT WATER PIPING.
M310	CONNECT NEW 3/4" HEATING HOT WATER PIPING TO EXISTING 1" HEATING HOT WATER PIPING.
M311	CONNECT NEW 1" HEATING HOT WATER PIPING TO EXISTING 1" HEATING HOT WATER PIPING.
M312	CONNECT NEW 3/4" HEATING HOT WATER PIPING TO EXISTING 1 1/4" HEATING HOT WATER PIPING.
M313	TEMPERATURE SENSOR TO DIE INTO BAS. TYPICAL THROUGHOUT.

SHEET TITLE

HVAC PIPING PLAN -
LEVEL 04

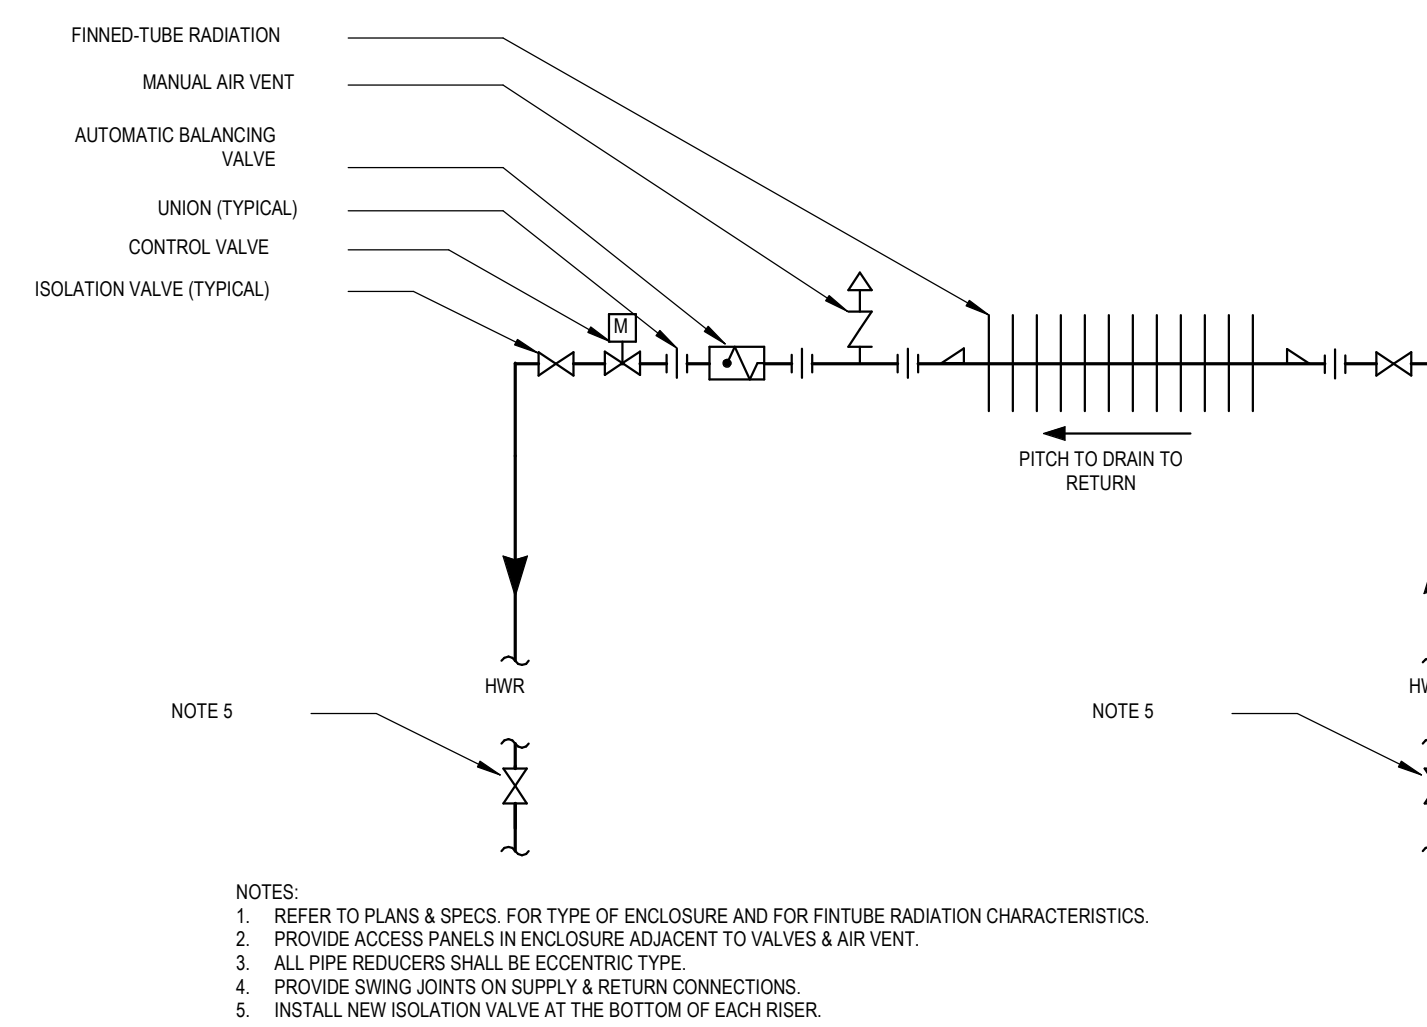
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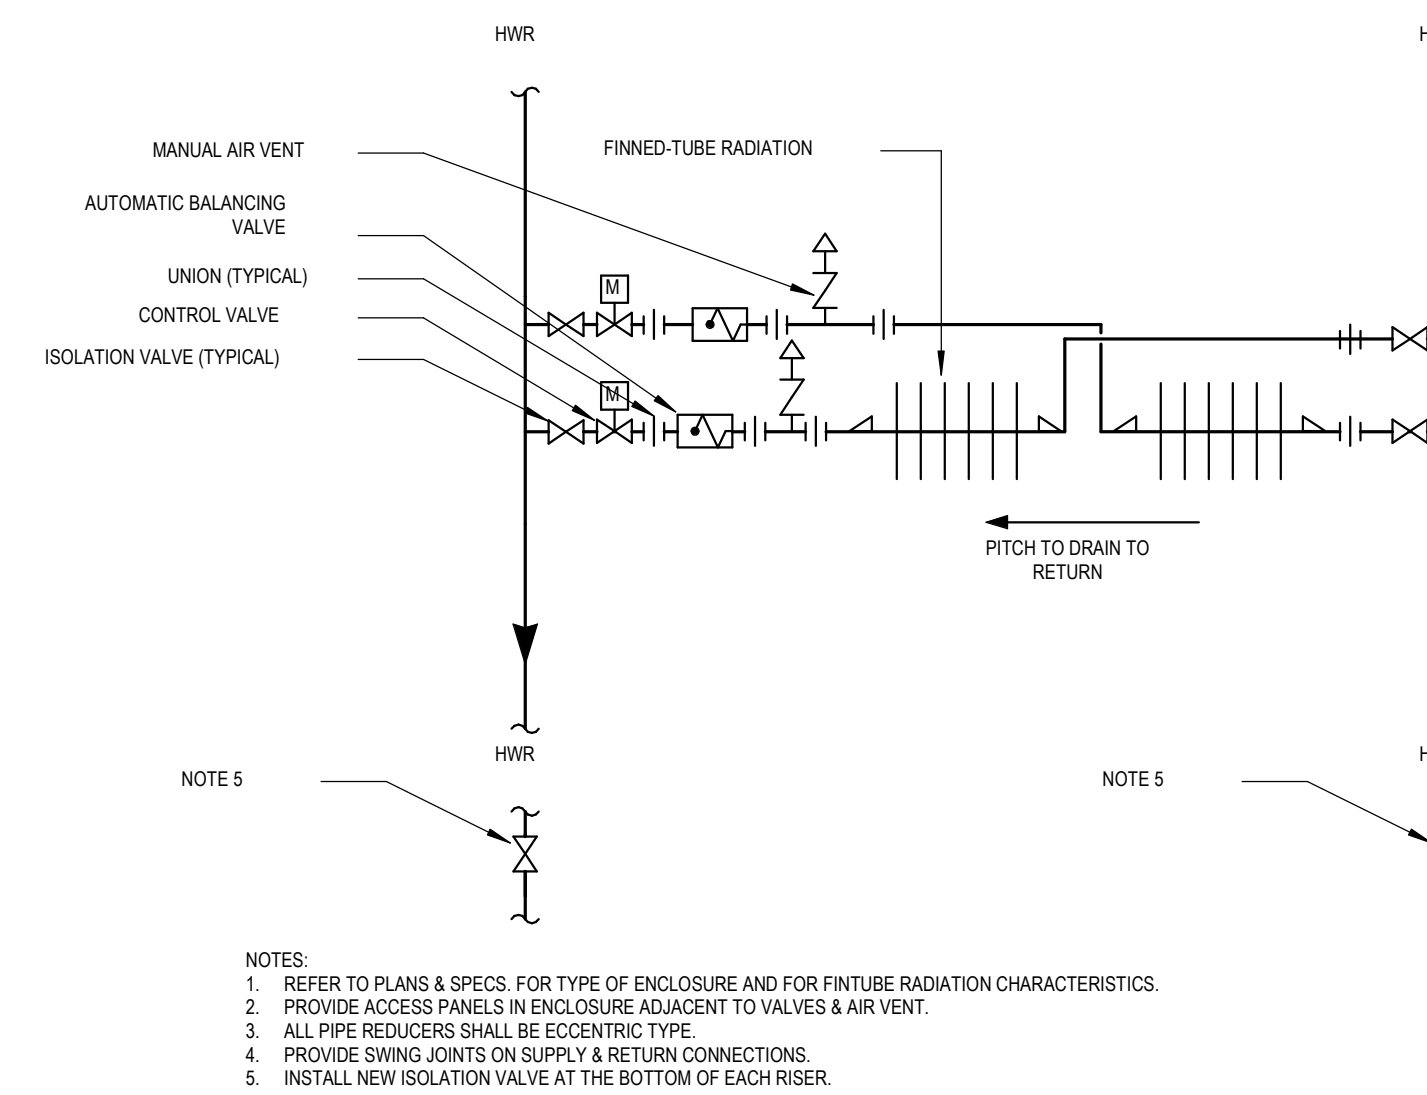
Project Number

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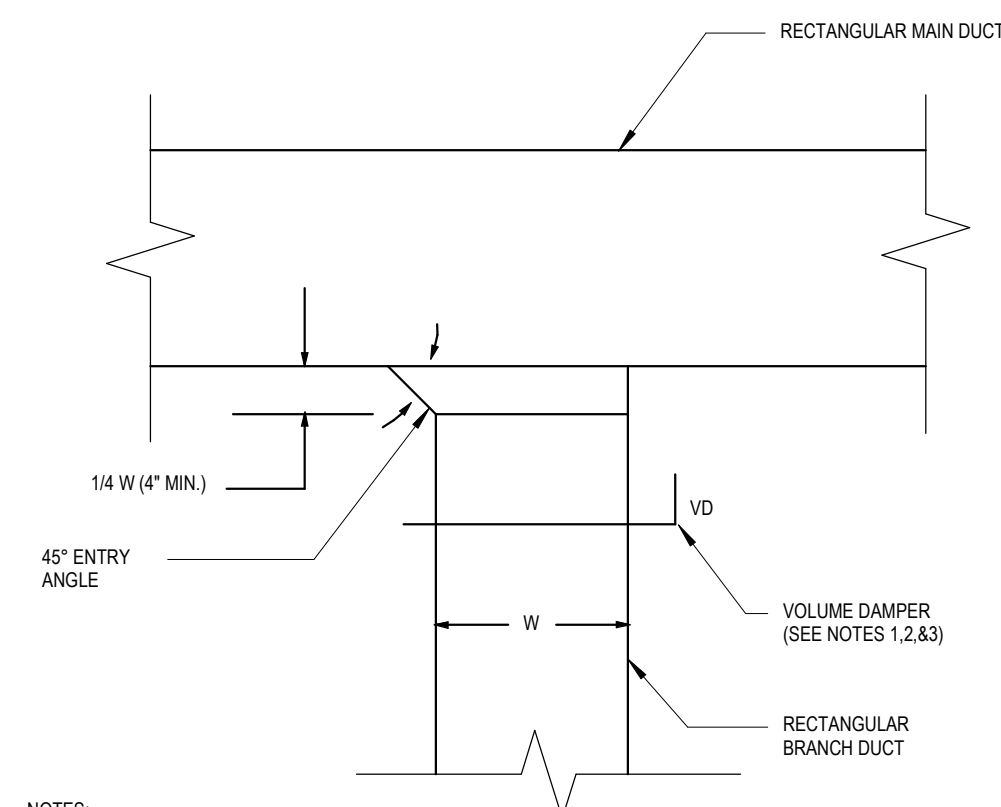
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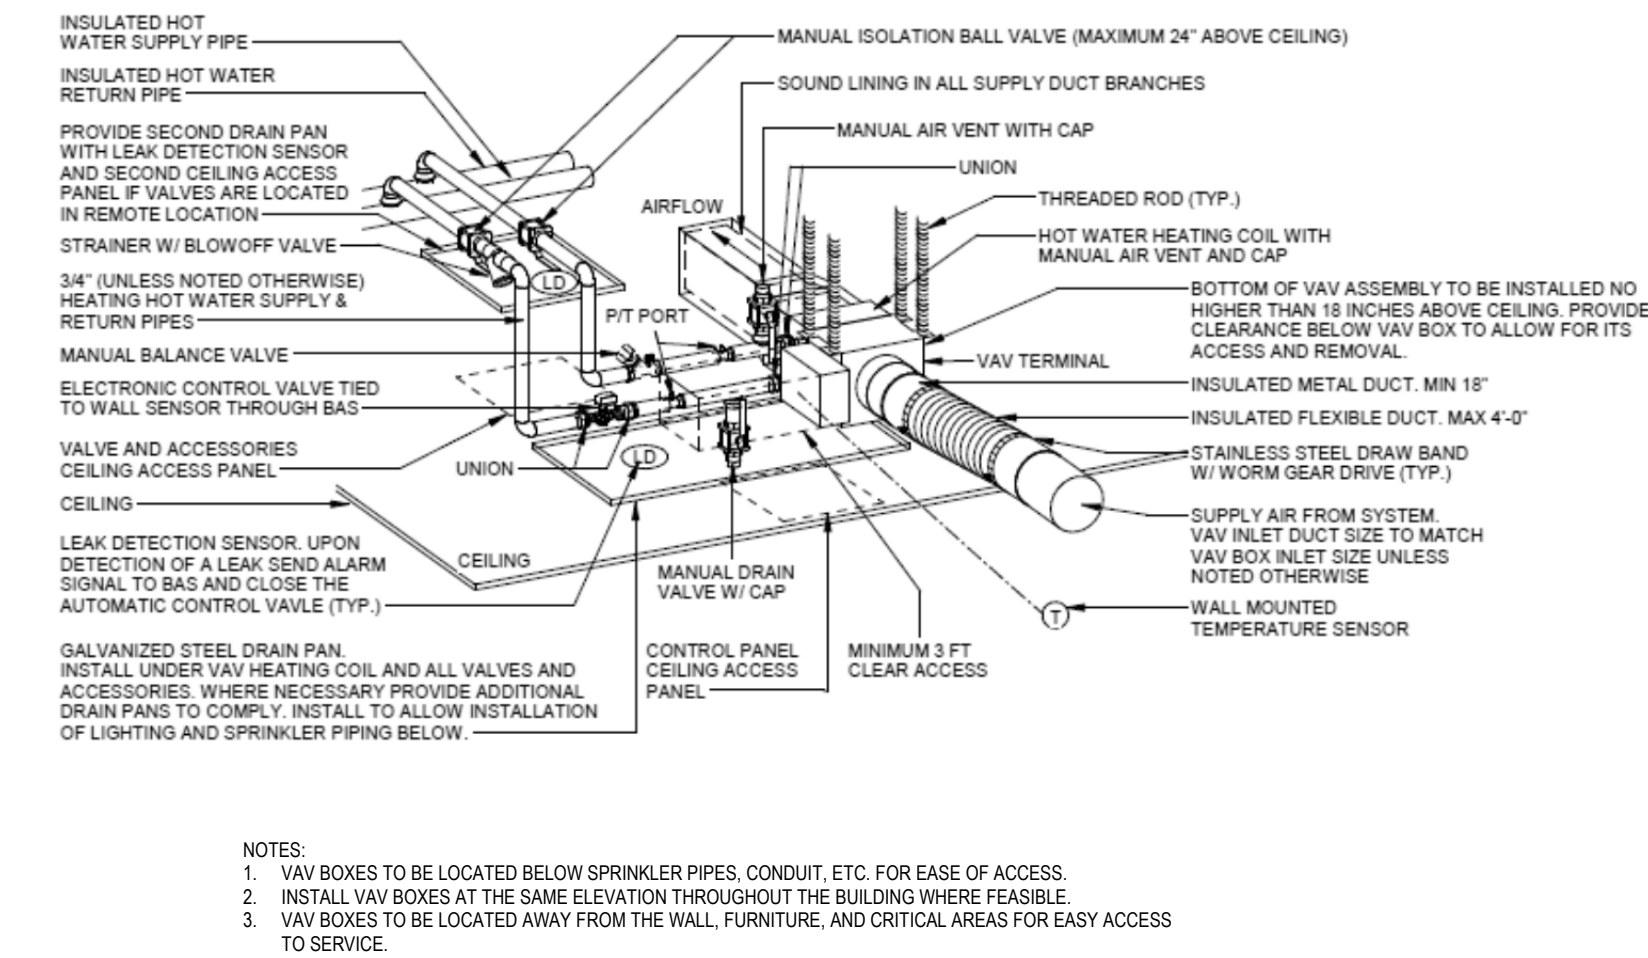
2 HOT WATER FINNED-TUBE RADIATION - UP FEED
SCALE: NOT TO SCALE




1 HOT WATER SPLIT FINNED-TUBE RADIATION - UP FEED
SCALE: NOT TO SCALE




4 TYPICAL LOW PRESSURE RECTANGULAR DUCT TAKE-OFF DETAIL
SCALE: NOT TO SCALE



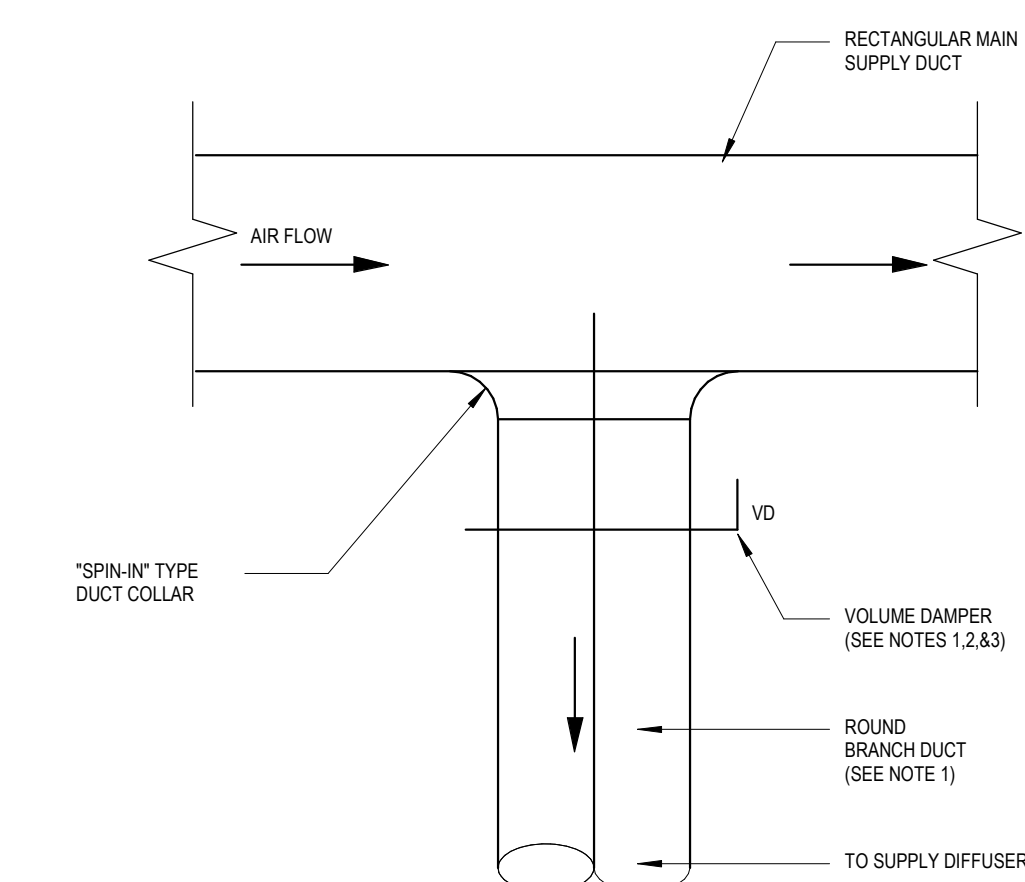
3 TYPICAL VAV TERMINAL WITH HOT WATER CONNECTION
SCALE: NOT TO SCALE



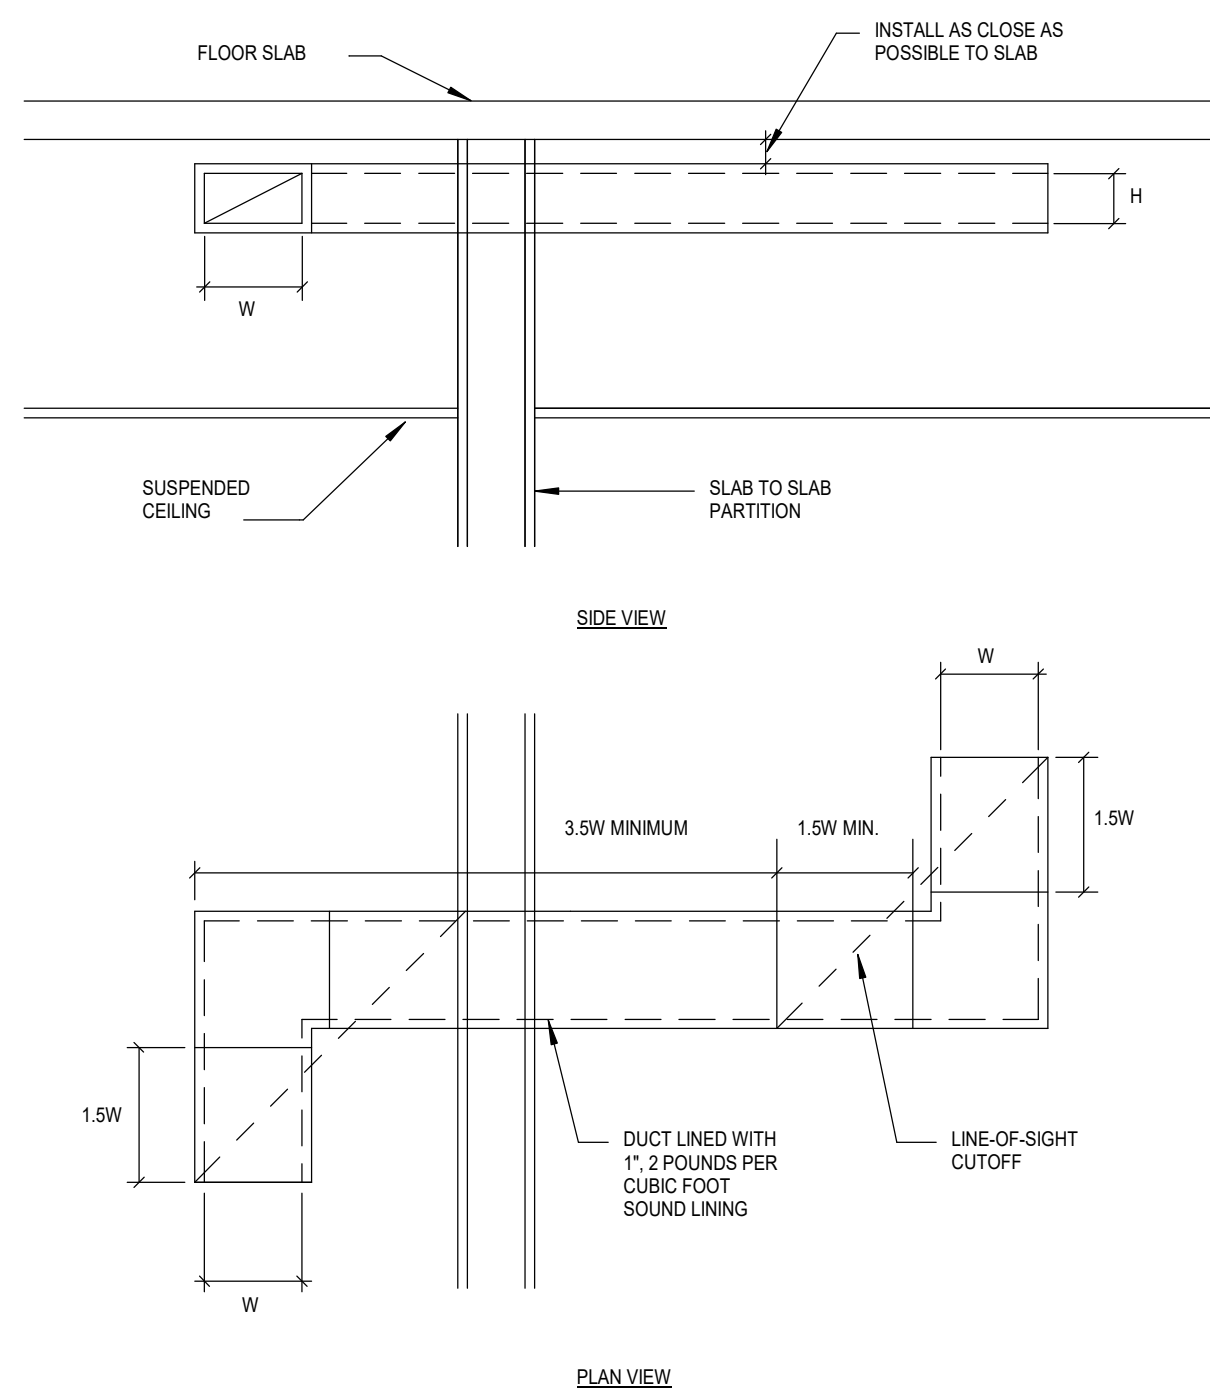6 TYPICAL LOW PRESSURE RECTANGULAR TO ROUND DUCT TAKE-OFF DETAIL
SCALE: NOT TO SCALE



5 TRANSFER AIR DUCT
SCALE: NOT TO SCALE

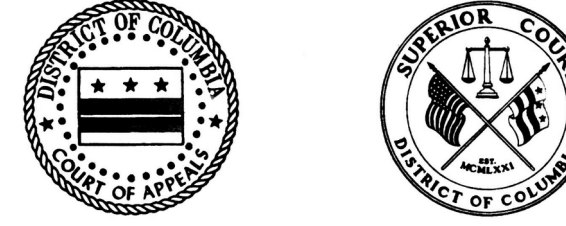

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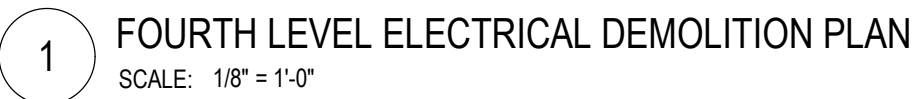
SEALS AND SIGNATURES

ISSUED FOR CONSTRUCTION	06/04/2021
PERMIT DOCUMENTS	06/04/2021
95% CONSTRUCTION DOCUMENTS	04/12/2021

SHEET TITLE


MECHANICAL DETAILS

PROJECT NUMBER		Project Number	
CD		2.M601	
SHEET NUMBER			




<p>A. COORDINATE WITH ES SERIES FOR ADDITIONAL DEMOLITION INFORMATION OF ELECTRICAL EQUIPMENT.</p> <p>B. DEMOLISH DEVICES AND DEVICES INDICATED WITH SUBSCRIPT (E) TO REMOVE EXISTING DEVICES. EQUIPMENT, BRANCH CIRCUITS AND FEEDERS IN THEIR ENTIRETY BACK TO THEIR POINT OF ORIGIN. TURN OFF AND LABEL CIRCUIT BREAKER SPACES FOR NEW DEVICES.</p> <p>C. EXTEND CONDUIT AND WIRE AS REQUIRED WHERE DEMOLITION WORK AFFECTS ELECTRICAL ENERGY TO DOWNSTREAM DEVICES.</p> <p>D. MAINTAIN AND PRESERVE EXISTING TO REMAIN EQUIPMENT AND DEVICES INDICATED WITH SUBSCRIPT (E) AND ASSOCIATED FEEDER CIRCUIT. PROTECT FROM DAMAGE DURING CONSTRUCTION.</p> <p>E. RELOCATE EQUIPMENT AND DEVICES INDICATED WITH SUBSCRIPT (R) AS INDICATED ON WORK PLANS. PROVIDE NEW CIRCUITING PER ES SERIES.</p>	<p>F. SEE MECHANICAL DRAWINGS FOR EXISTING TO REMAIN MECHANICAL EQUIPMENT/MATERIAL ALL ASSOCIATED ELECTRICAL DEVICES, DEVICES AND FEEDERS TO BE RELOCATED, DEMOLISHED OR MECHANICAL EQUIPMENT TO BE DEMOLISHED AND DEMOLISHED ASSOCIATED CONTROLLER, DISCONNECT, WIRING AND CONDUIT IN THEIR ENTIRETY BACK TO THEIR POINT OF ORIGIN.</p> <p>G. QUANTITY AND LOCATION OF DEVICES SHOWN ON PLANS ARE APPROXIMATE. FIELD VERIFY DEVICES AND LOCATIONS.</p> <p>H. PRESERVE EXISTING TO REMAIN CEILING, FLOORS, WALLS AND PANELS.</p> <p>I. SELECT MATERIAL MAY BE REQUIRED FOR NEW CONSTRUCTION AND MAY NOT BE DELINEATED ON THIS DRAWING. CAREFULLY COORDINATE DEMOLITION WITH NEW CONSTRUCTION (PARTITION AND DEMOLISHED CEILING) PLANS TO VERIFY ACTUAL EXTENT OF DEMOLITION.</p>	<p>K. EXAMINE THE DRAWINGS OF OTHER TRADES AND BE FAMILIAR WITH THE DEMOLITION REQUIRED BY OTHER TRADES. PERFORM ELECTRICAL DEMOLITION. DEMOLITION WORKER RELATION REQUIRED TO FACILITATE DEMOLITION WORK OF OTHER TRADES. WHETHER OR NOT SPECIFICALLY INDICATED. RECYCLE OR DISPOSE MATERIALS OFF SITE AND INCLUDE ALL COSTS IN BID. HANDLE ALL MATERIALS IN ACCORDANCE WITH LEAD REQUIREMENTS, ALL FEDERAL, STATE, AND LOCAL REGULATIONS.</p> <p>L. PRIMER, PAINT, AND PAINT TO MATCH WALL FINISHES WHERE DEVICES ARE REMOVED BUT EXISTING WALLS REMAIN INTACT.</p>	<p>N. WHERE EXISTING BUILDING SERVICES AND/OR EQUIPMENT THAT IS TO REMAIN IN USE ARE REQUIRED TO BE SHUT DOWN, COORDINATE WITH THE OWNER'S REPRESENTATIVE, INCLUDE ALL ASSOCIATED OVERTIME COSTS TO PERFORM THIS WORK DURING WEEKENDS AND EVENINGS. INCLUDE ALL COSTS FOR PROVIDING TEMPORARY POWER WHERE SHUT DOWN MUST COVER ALL PERIODS LONGER THAN THE PERIODS FOR WHICH THE OWNER IS RESPONSIBLE TO PROVIDE TEMPORARY POWER. ADVANCE NOTICE THAT STARTS WITH THE DEMOLITION OF THE BUILDING.</p> <p>O. PROVIDE CODE COMPLIANT SUPPORT TO EXISTING TO REMAIN UNDISRUPTED CONDUITS AND BOXES WHERE GELINGS ARE TO BE REMOVED. REPAIR BRANCH CIRCUITS AND RELOCATE JUNCTION BOXES AS REQUIRED TO FACILITATE INSTALLATION OF NEW EQUIPMENT AND SYSTEMS IN CEILING SPACES.</p> <p>P. PROVIDE NEW TYPED DIRECTORIES FOR PANELBOARDS AFFECTED BY DEMOLITION WORK.</p> <p>Q. PROVIDE A GRAB BATCH IS TO BE OF SUFFICIENT PRESERVE AND MAINTAIN ELECTRICAL SYSTEMS WITHIN OR OUT OF SCOPE AREA, OUT OF SCOPE SYSTEMS TO REMAIN ACTIVE THROUGHOUT DEMOLITION AND CONSTRUCTION.</p> <p>R. DEMOLITION WORK, TEMPORARY POWER AND MODIFICATIONS TO MAINTAIN ELECTRICAL CONTINUITY TO EXISTING TO REMAIN/RELOCATE SYSTEMS SHALL NOT INTERRUPT UPSTREAM GROUND FAULT PROTECTION. PROVIDE TEMPORARY FEEDER CIRCUIT BREAKERS, ELECTRICAL CONDUIT, SURVEY EXISTING GROUND FAULT PROTECTION WITHIN THE BUILDING AND COORDINATE DEMOLITION WORK. TEMPORARY POWER AND MODIFICATION TO MAINTAIN ELECTRICAL CONTINUITY TO EXISTING TO REMAIN SYSTEMS WITH GENERAL CONTRACTOR, DEMOLITION CREW AND OWNER PRIOR TO DEMOLITION TO AVOID GROUND FAULT DISRUPTIONS TO ANY PORTION OF THE BUILDING.</p>
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ED001	DEMOLISH ALL ELECTRICAL POWER DEVICES/ FIXTURES AND ALL ASSOCIATED WIRING BACK TO POINT OF ORIGIN IN THIS SPACE.
ED002	PRIOR TO DEMOLITION COORDINATE WITH EXISTING CONDITIONS TO DETERMINE ANY ACTIVE TERRAZZO POKE-THRU SYSTEMS WITHIN CORRIDOR. COORDINATE WITH OWNER TO PRESERVE AND REROUTE OR RELOCATE EXISTING TO REMAIN TERRAZZO POKE-THRU SYSTEMS.

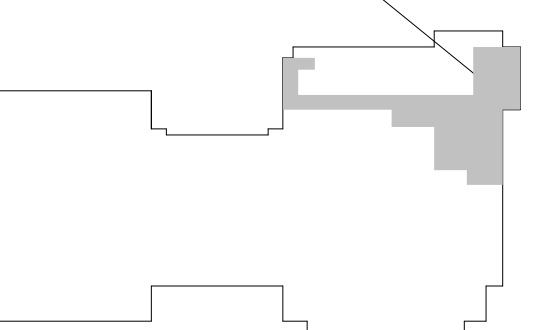

2808.000

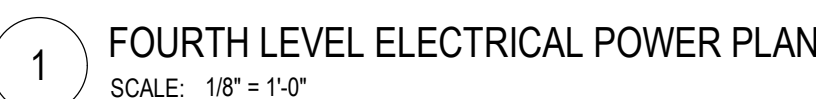2.ED.204



- A. SEE E0 SERIES COVER SHEET FOR ABBREVIATIONS, SYMBOLS, GENERAL NOTES AND DEVICE MOUNTING HEIGHT OF WALL MOUNTED DEVICES, ION.
- B. SEE E6 AND E7 SERIES FOR RECEPTACLE CONTROL DETAILS AND PROGRAMMING.
- C. LINE VOLTAGE DROP TO 2% FOR FEEDERS AND 3% FOR BRANCH CIRCUITS.
- D. CONTRACTOR SHALL SCAN FLOORS PRIOR TO CORE DRILLING FOR POKE-THRU DEVICES. COORDINATE CORE DRILLING WITH OWNER.
- E. COORDINATE ALL DEVICE LOCATIONS AND MOUNTING HEIGHTS WITH ARCHITECTURAL AND SECURITY DRAWINGS PRIOR TO ROUGH-IN.
- F. ARCHITECT HAS FINAL APPROVAL OVER ALL FINISHES.
- G. THE CONTRACTOR SHALL COORDINATE EXACT LOCATION OF EQUIPMENT TO POWER CONNECTIONS WITH EQUIPMENT INSTALLER PRIOR TO ROUGH-IN.

E201	COORDINATE WITH GC AT BEGINNING OF PROJECT BEFORE TERRAZZO FLOORING CHANGES ACCESS POPE-THURSDAY TO SURVEY AND LOCATE EXISTING INTERIOR ELECTRICAL WIREWAYS AND ACTIVE ELECTRICAL WIREWAYS ARE FOUND. REROUT AND REPAIR EXISTING TO NEW ROUTING TO AVOID INTERFERENCE TO NEW IN PLACE INACTIVE ELECTRICAL WIREWAYS.	E203	PROVIDE 3/4" CONDUIT FOR ALL SECURITY DEVICES AT ALL WALLS WITH CERESTROTES. ROUTE ALL SECURITY DEVICES HORIZONTALLY AT TOP OF CERESTROTES WITH INTERIOR CERESTROTES TO WALLS TO CONCEAL ALL RACEWAYS FROM VIEW WITH PARTITION CERESTROTES AND AVOID INTERFERENCE TO CERESTROTES. SUBMIT COORDINATION DRAWINGS AS ACTION SUBMITTAL FOR REVIEW PRIOR TO INSTALLING RACEWAYS IN PARTITIONS WITH CERESTROTES FOR FIRE ALARM AND SMOKE DETECTORS ROUTING.
E202	COORDINATE WITH INTERIOR CERESTROTES ELEVATIONS TO AVOID INTERFERENCE TO CERESTROTES. REROUT AND REPAIR EXISTING TO NEW ROUTING TO AVOID INTERFERENCE TO NEW IN PLACE INACTIVE ELECTRICAL WIREWAYS. SUBMITTAL FOR REVIEW PRIOR TO INSTALLING RACEWAYS IN PARTITIONS WITH CERESTROTES. USE INTERIOR ELEVATIONS FOR TYPICAL ROUTING.	E204	INTERIOR RATED SWITCH FOR GARBAGE DISPOSAL, SHOWN COORDINATE WITH MECHANICAL CONTRACTOR TO PROVIDE CORNER AND PLUG GARBAGE DISPOSAL.

PROJECT NUMBER
CD
 SHEET NUMBER
2.E.20



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SEALS AND SIGNATURES



PROJECT NUMBER
 **2.E.504**
 SHEET NUMBER



1. COORDINATE EXACT LOCATIONS OF FURNITURE FEEDS AND CABLE TERMINATIONS WITH SYSTEMS FURNITURE VENDOR.

1. COORDINATE EXACT LOCATIONS OF FURNITURE FEEDS AND CABLE TERMINATIONS WITH SYSTEMS FURNITURE VENDOR.

CD

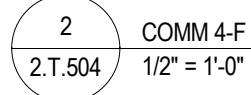


2.T.304





1. CONTRACTOR SHALL IDENTIFY AND PROTECT ANY CABLING SERVING LOCATIONS OUTSIDE THE EXTENTS OF THIS PROJECT TO ENSURE CABLING AND SYSTEMS REMAIN OPERATIONAL FOR OTHER AREAS OF THE BUILDING.
2. CONTRACTOR SHALL DEMO AND REMOVE ALL EXISTING HORIZONTAL CABLING WITHIN THE PROJECT EXTENTS. CABLING SHALL BE REMOVED TO THE RACK LOCATION AND NOT BE ABANDONED IN PLACE. UNUSED RACK MOUNTED PATCH PANELS SHALL BE DEMOLISHED AND REMOVED.

1. CONTRACTOR SHALL REUSE EXISTING 2-POST RACK AND PROVIDE NEW FIBER TERMINATION PANELS AND NEW HORIZONTAL CATEGORY 6A PATCH PANELS PER THE SPECIFICATIONS TO SUPPORT NEW CABLING INSTALLED AS PART OF THIS PROJECT.
2. CONTRACTOR SHALL CONFIRM FINAL RACK ELEVATIONS WITH OWNER.
3. CONTRACTOR SHALL INSTALL OFCI NETWORK SWITCHES IN EXISTING 2-POST RACK.



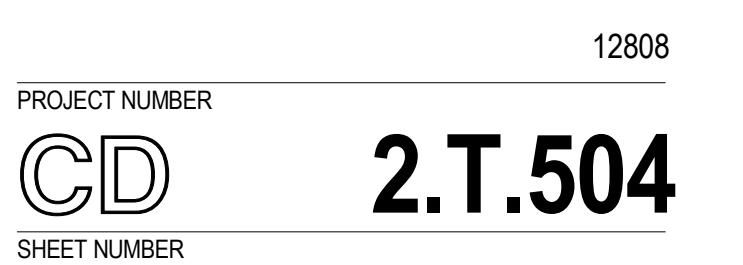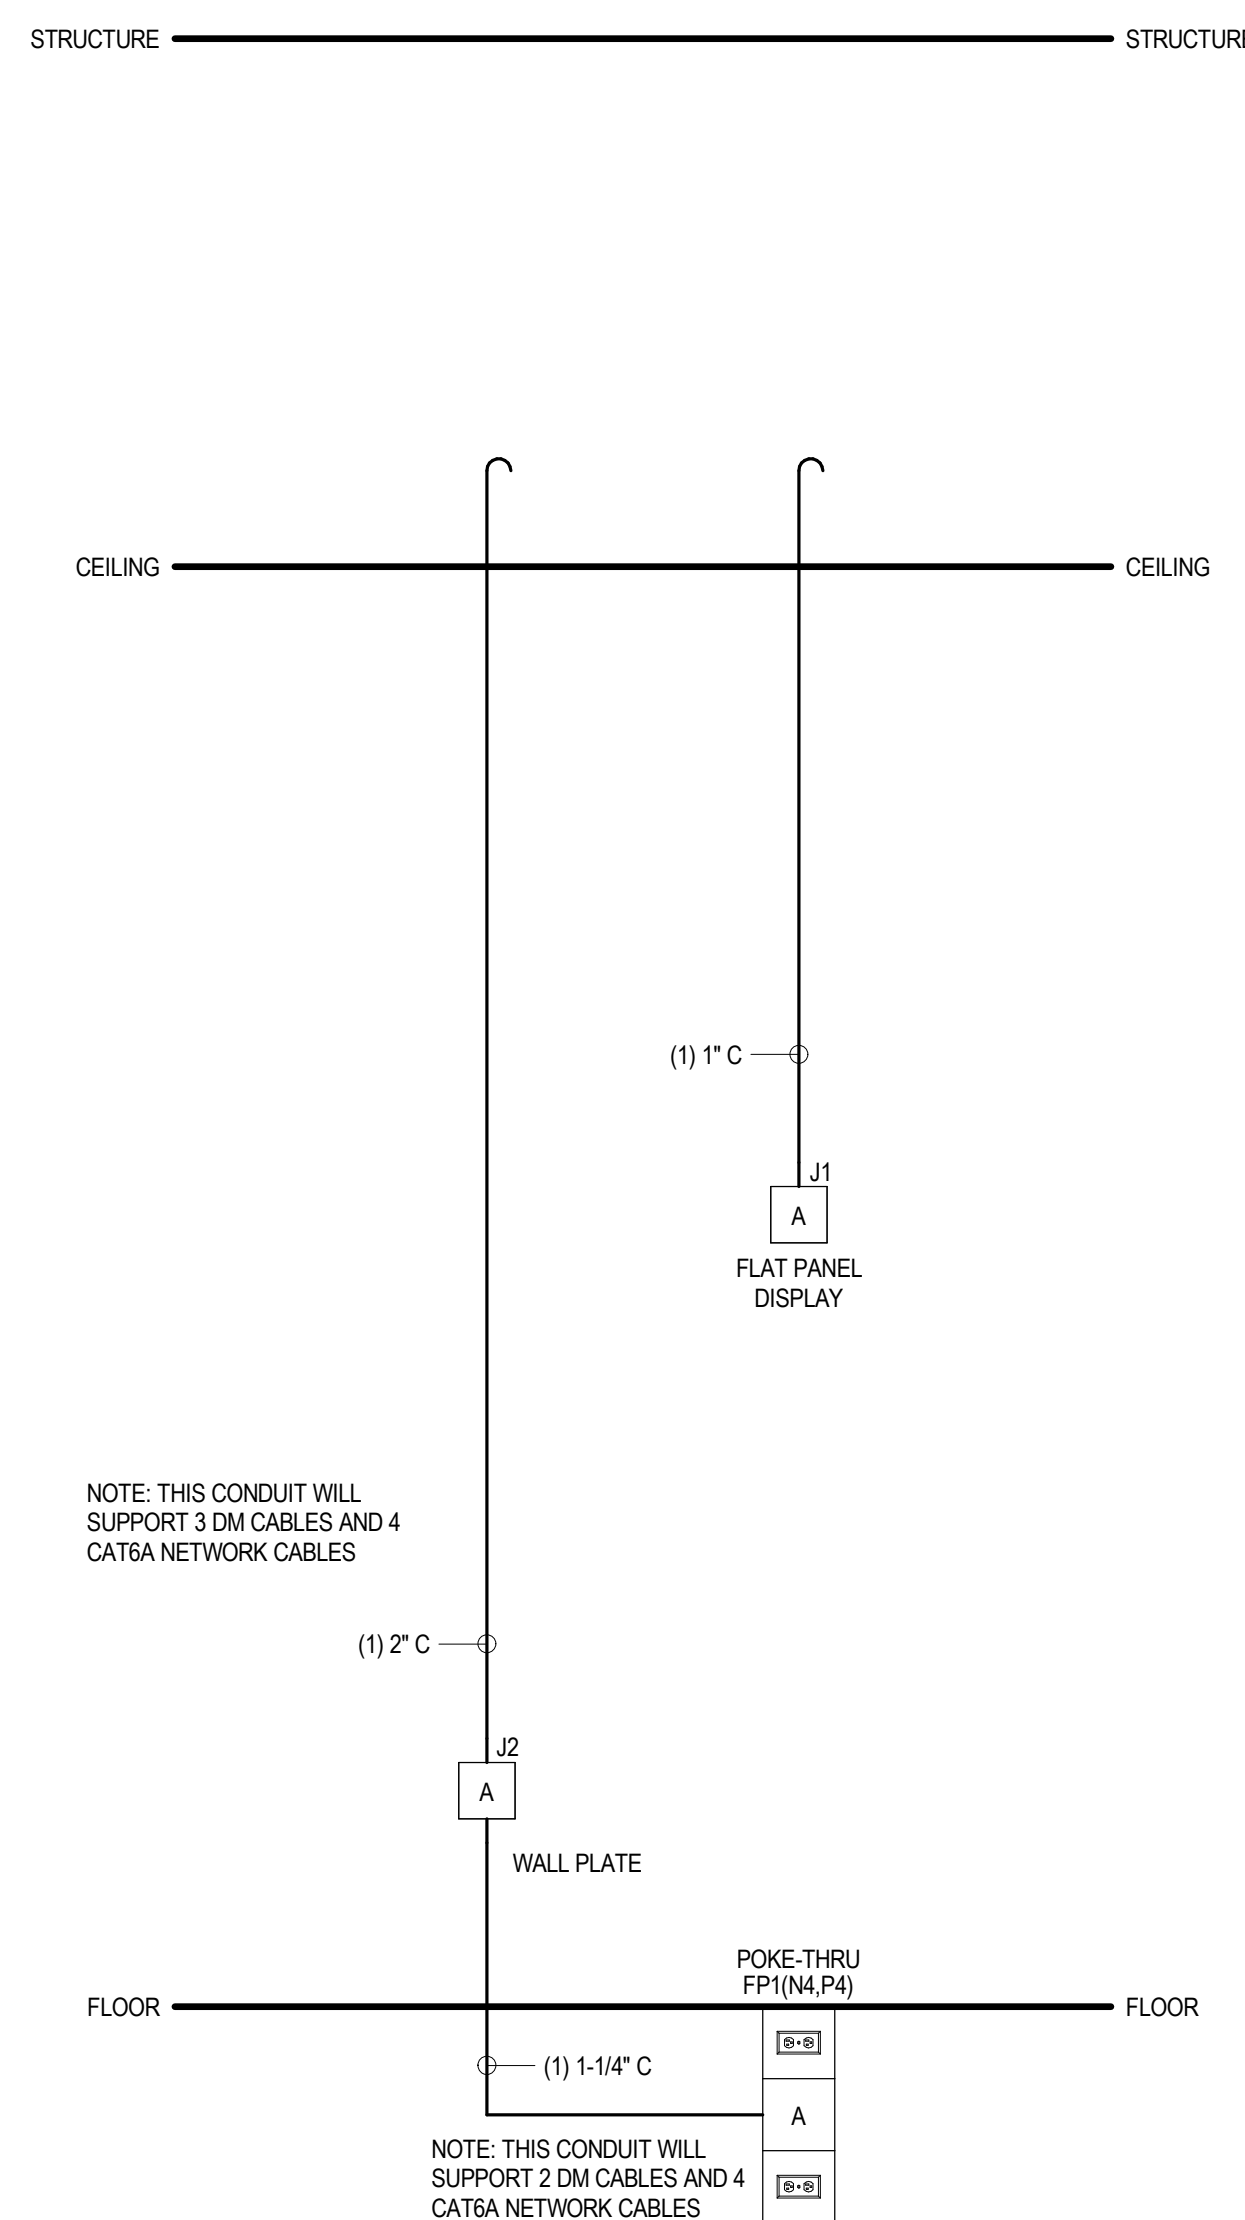
1. COORDINATE EXACT LOCATIONS OF FURNITURE FEEDS AND CABLE TERMINATIONS WITH SYSTEMS FURNITURE VENDOR.






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2.T.601

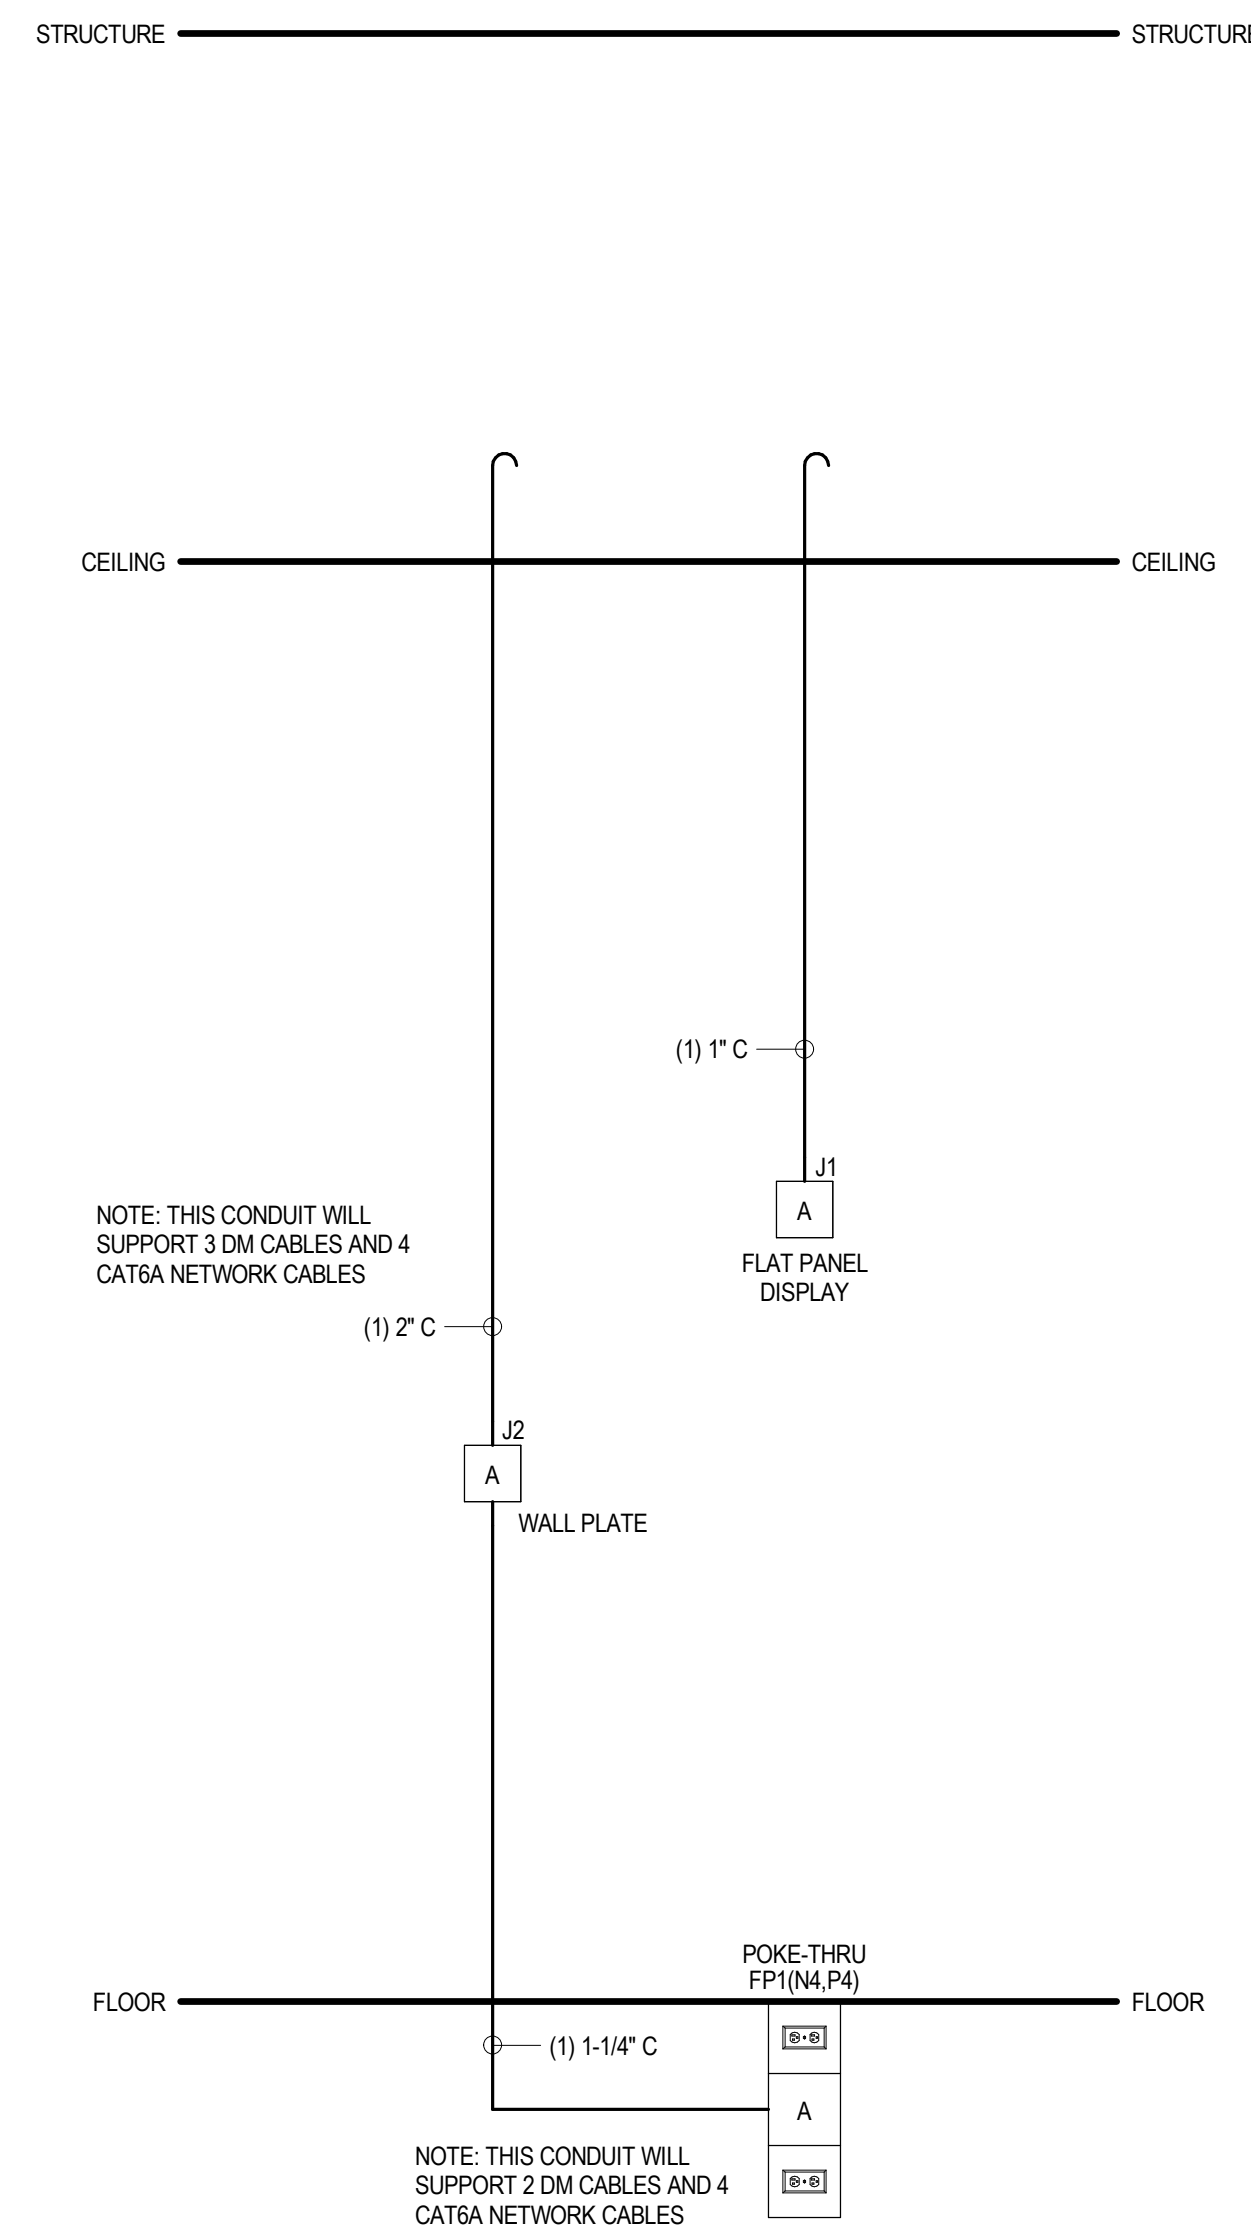
SMALL CONFERENCE ROOM - 4054
NTS



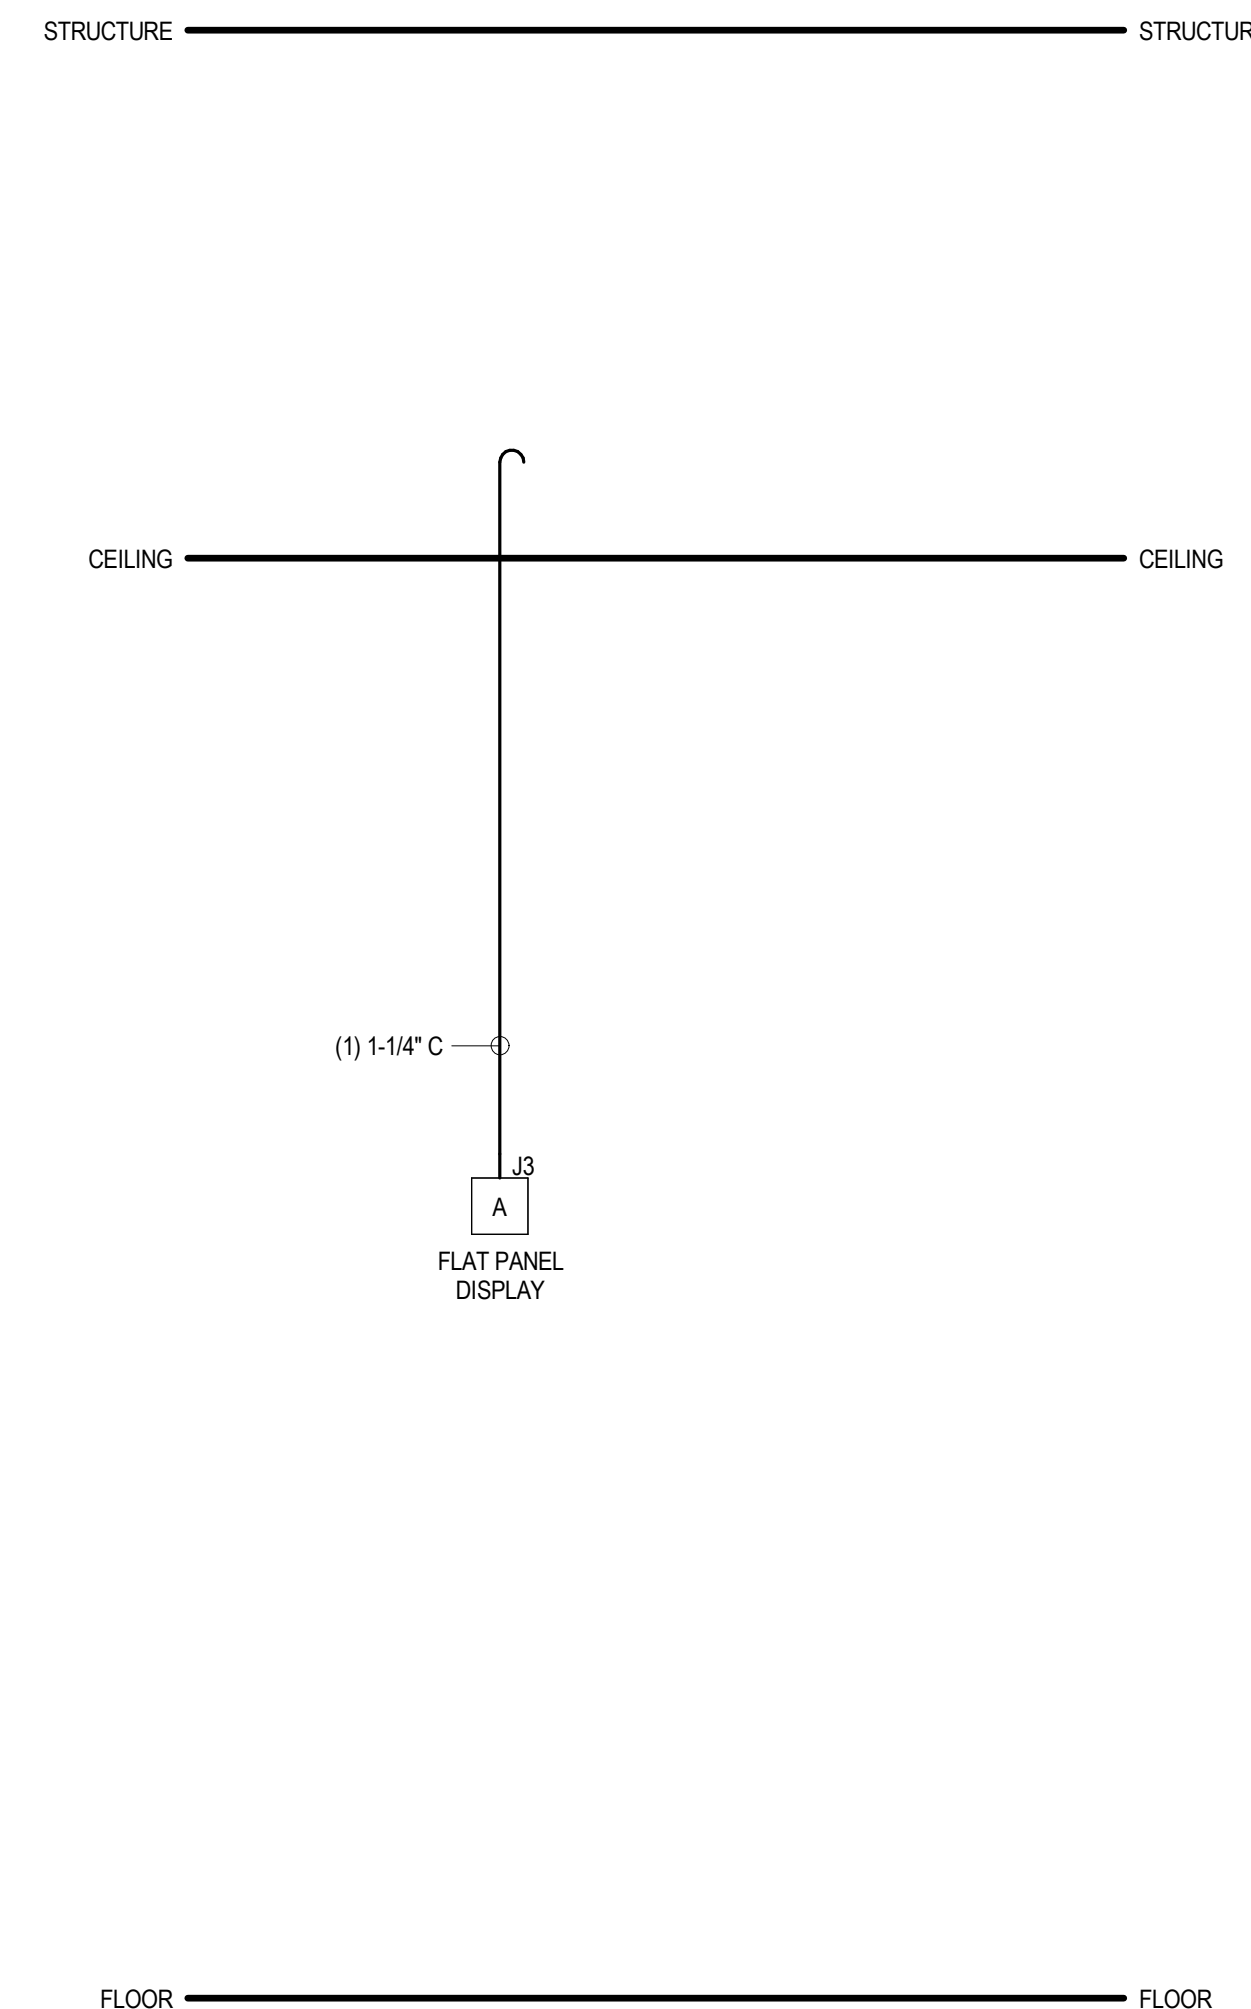2 LARGE CONFERENCE ROOM - 4001
2.T.601 NTS



3	LUNCH ROOM 4048
2.T.601	NTS

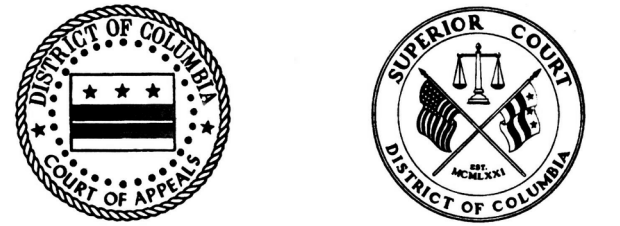

HCMC Fourth Floor East Magistrate Judges Chamber
Renovation (Phase 2A and 2B)
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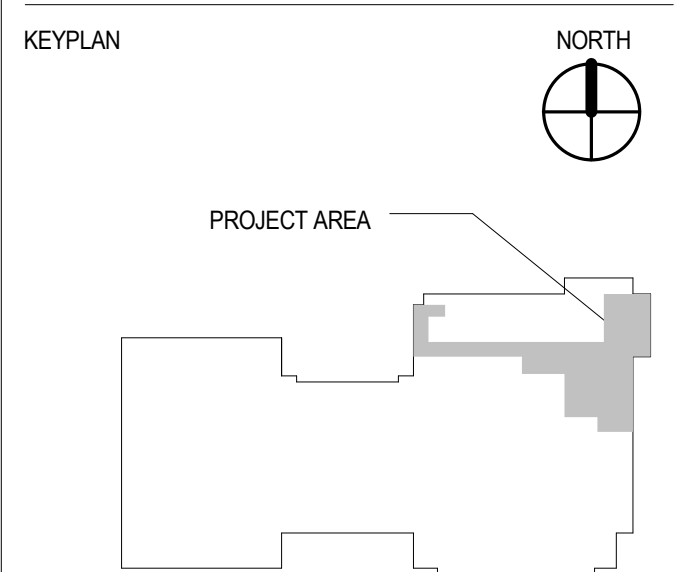
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
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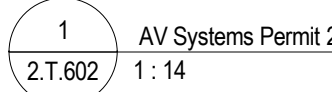
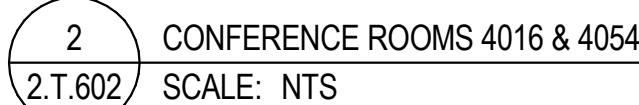
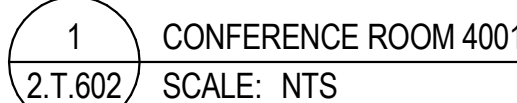
SEALS AND SIGNATURES

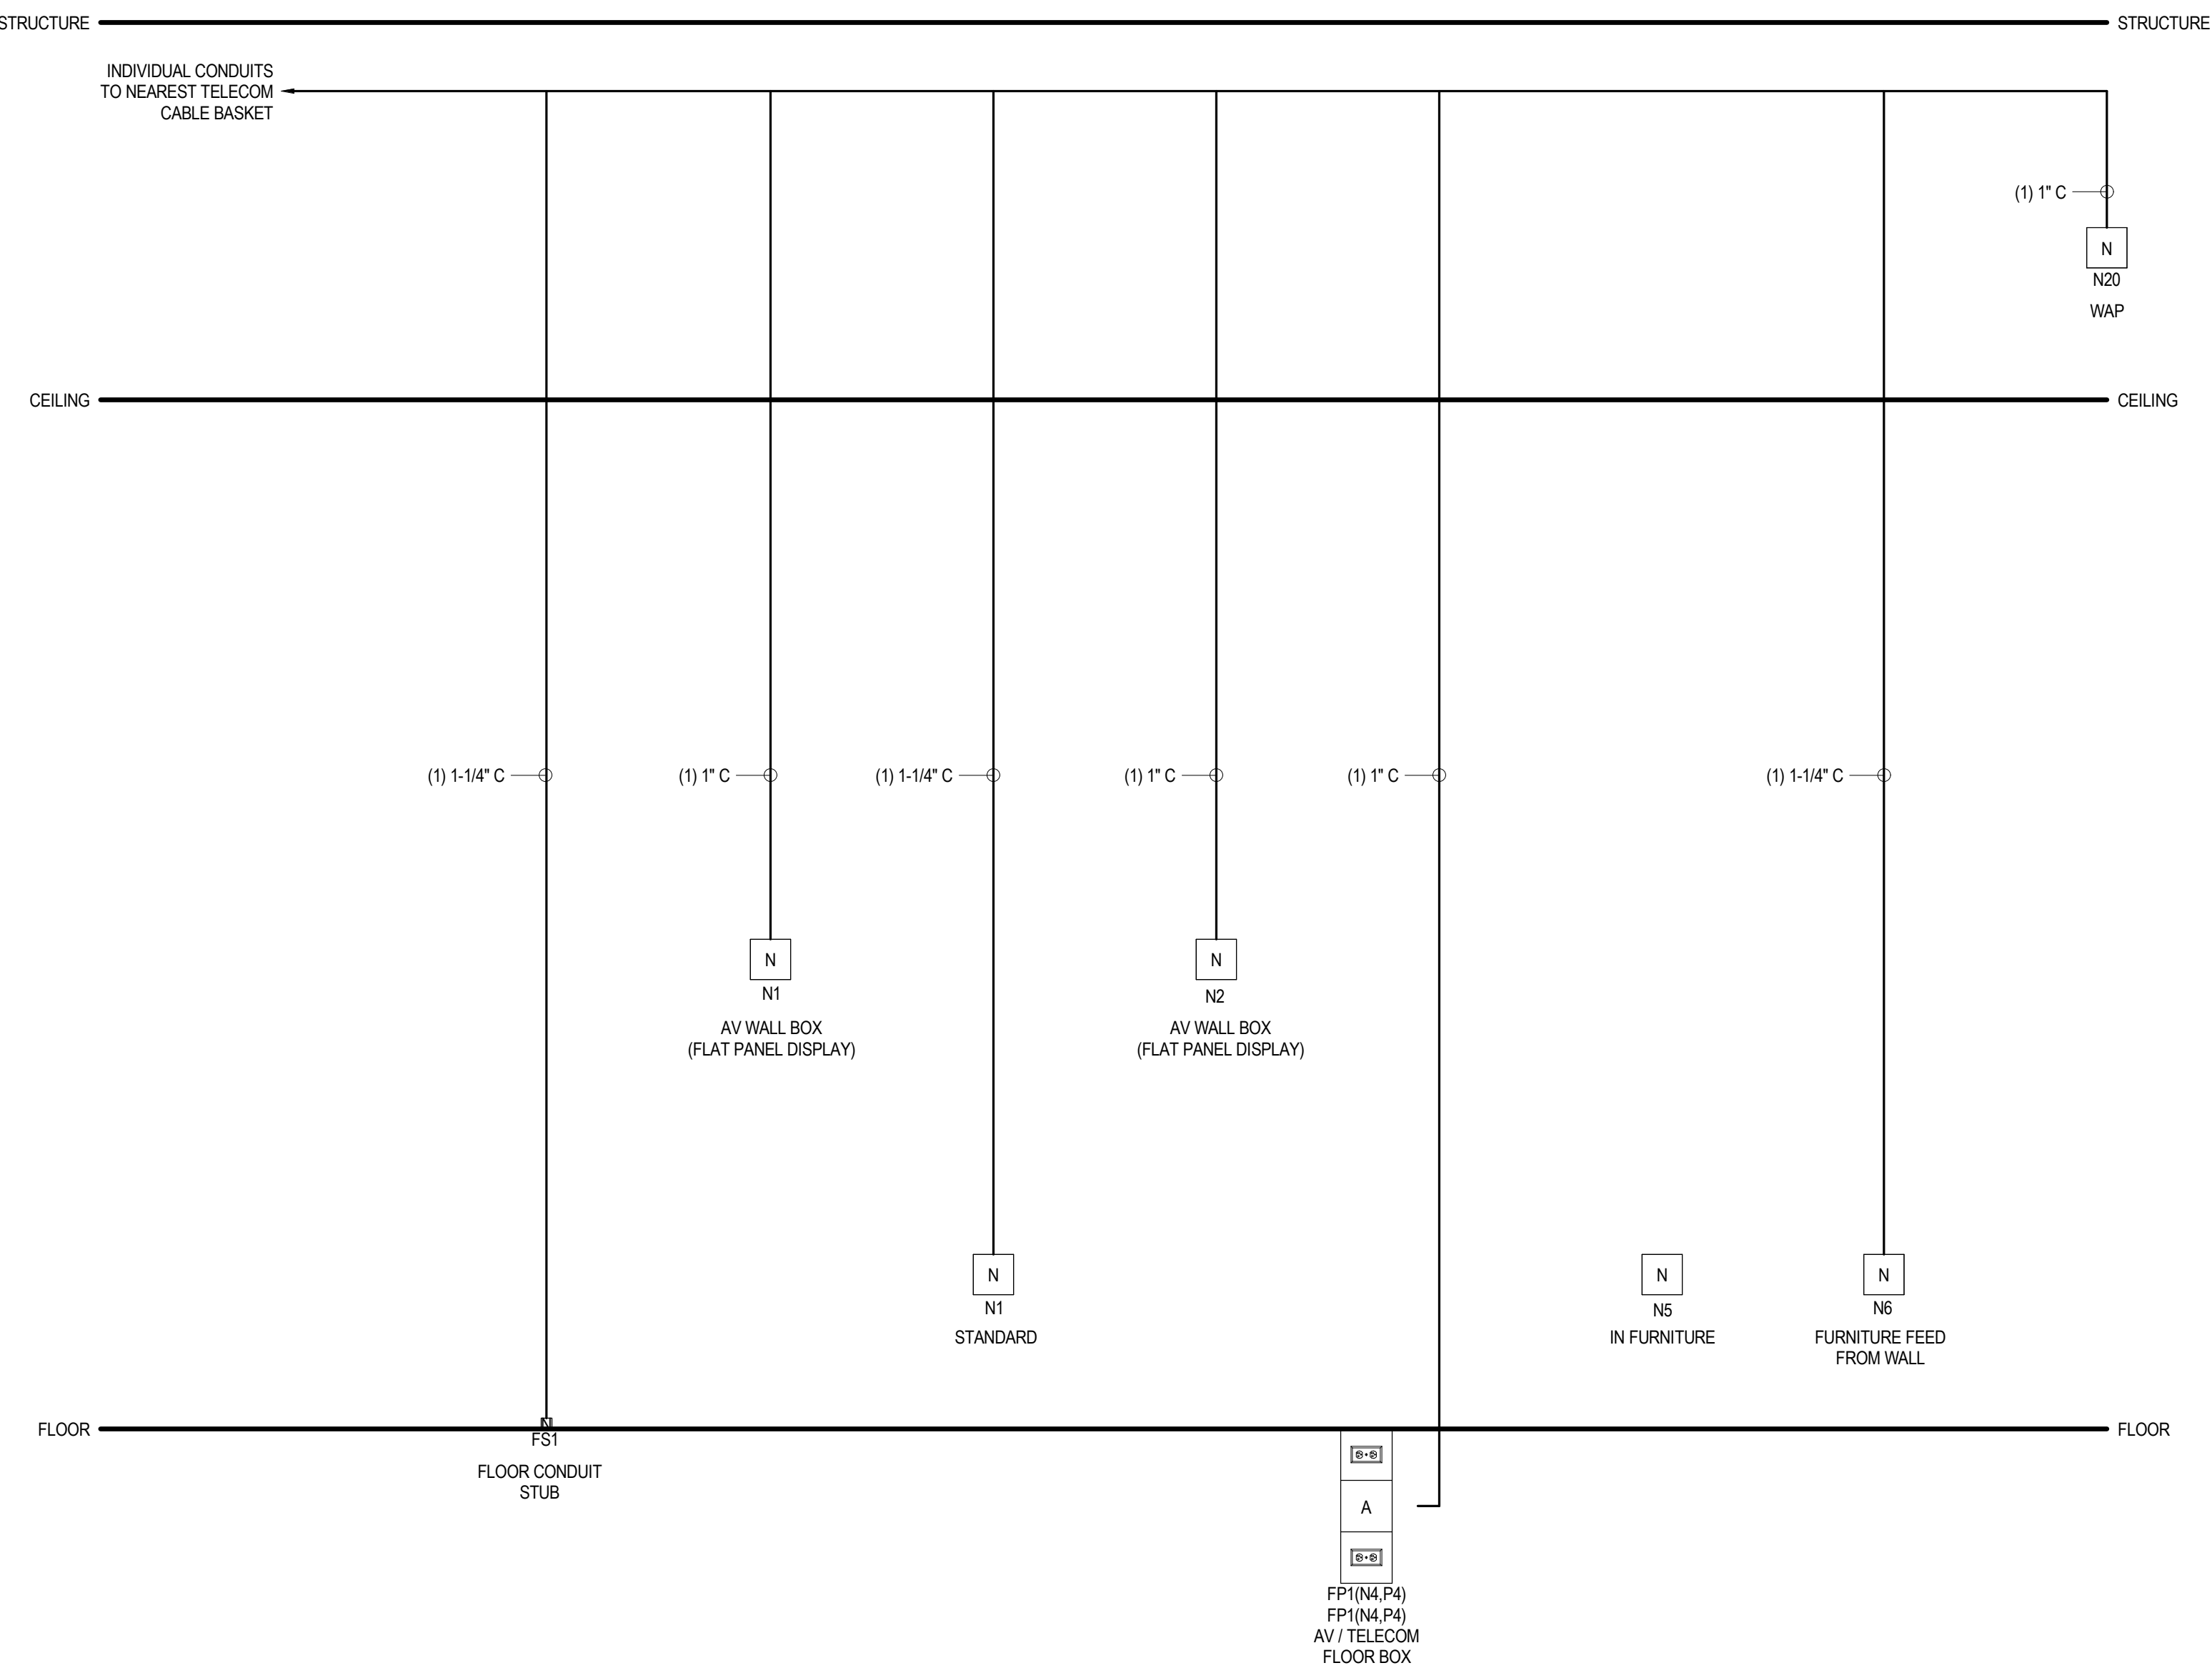


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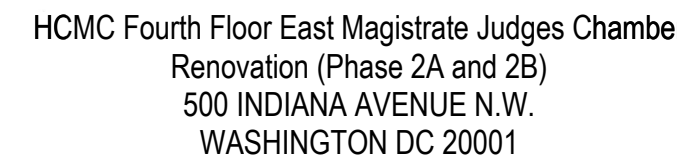
AUDIOVISUAL
INFRASTRUCTURE ROOM
RISERS

PROJECT NUMBER
 2.T.601
 SHEET NUMBER





BUILDING RISER CABLE SCHEDULE		
DESIGNATION	CABLE TYPE	CABLE CONFIGURATION
①	OPTICAL	12-STRAND OS2 FOSM, ARMORED, PLENUM RATED & 24-STRAND OM4 FOSM, ARMORED, PLENUM RATED



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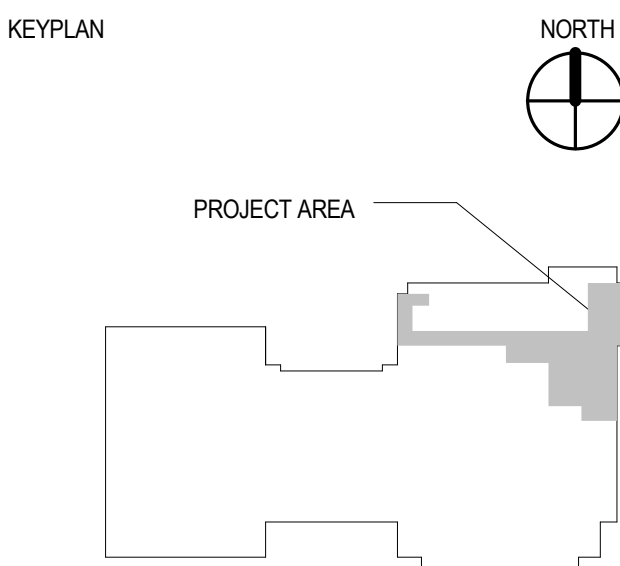
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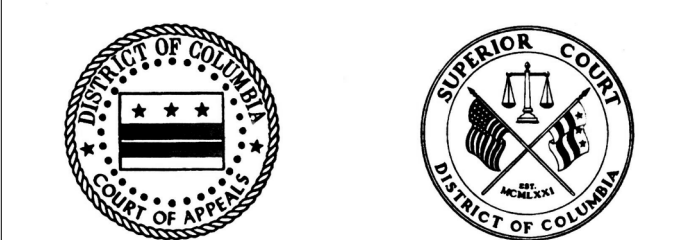
SEALS AND SIGNATURES



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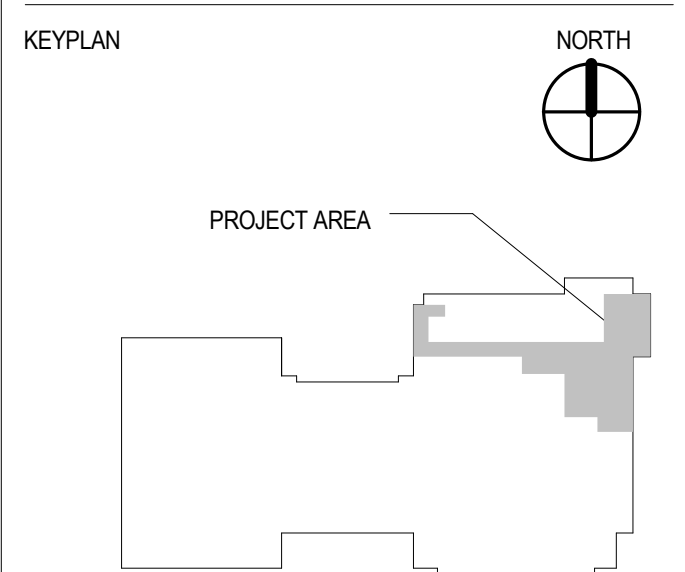
TELECOM BUILDING AND
TYPICAL CONDUIT RISER

PROJECT NUMBER
CD
SHEET NUMBER
2.T.701

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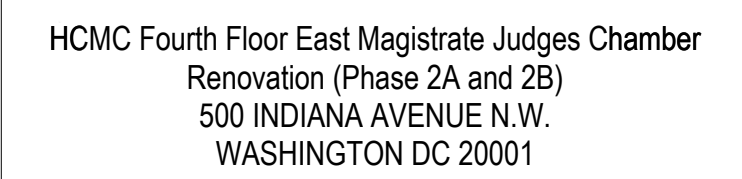
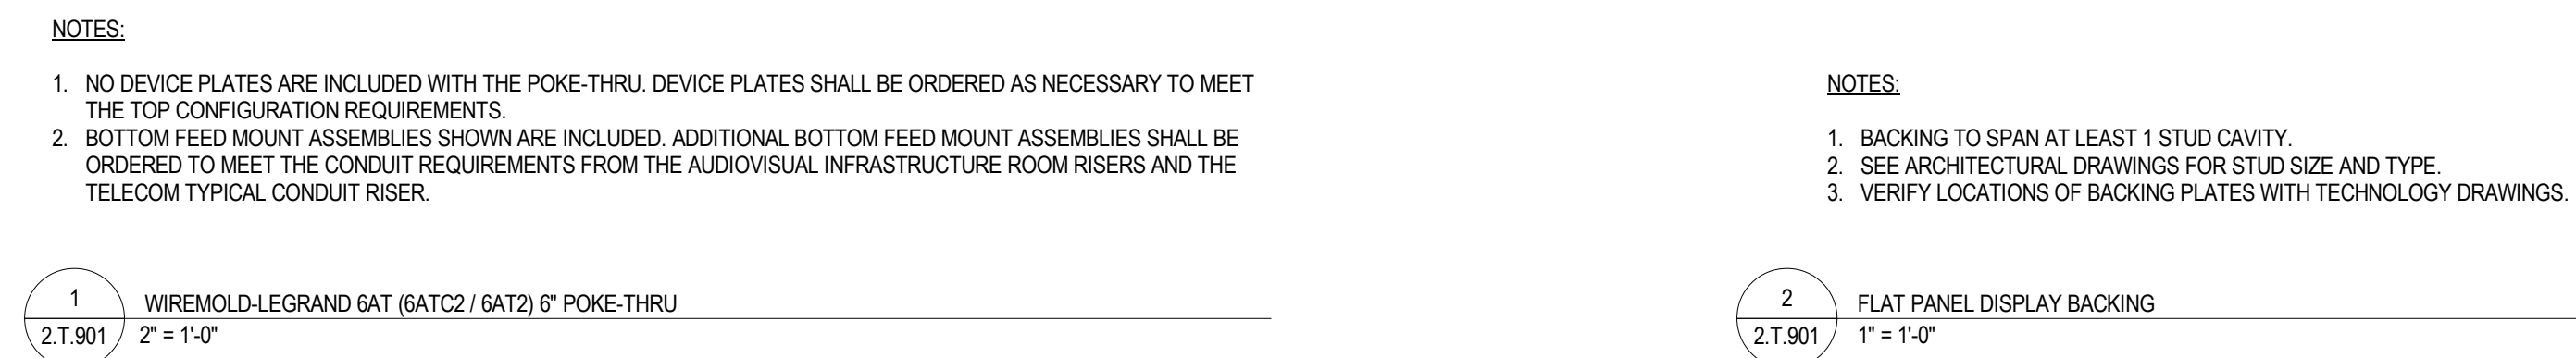
TECHNOLOGY INFRASTRUCTURE ELEVATIONS

PROJECT NUMBER

12808

CD
SHEET NUMBER

2.T.801



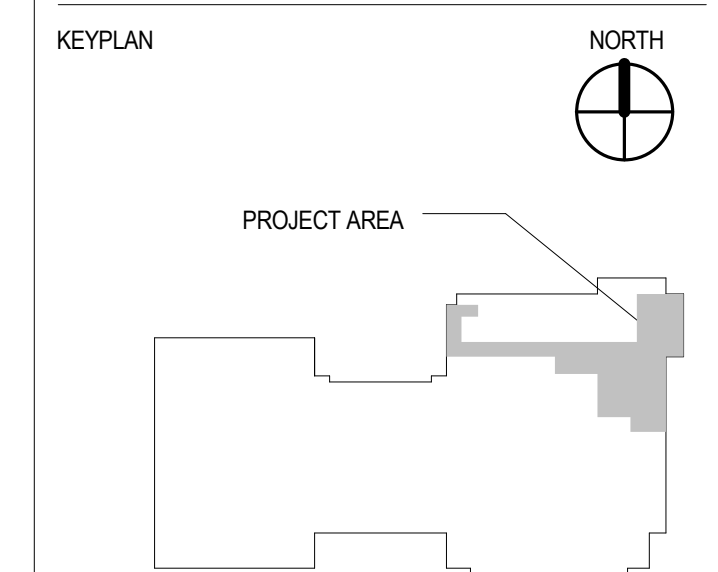
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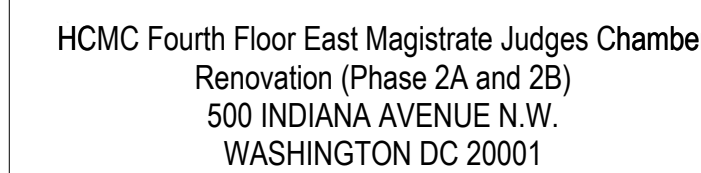
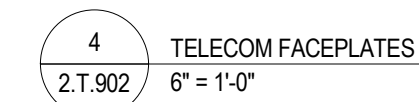
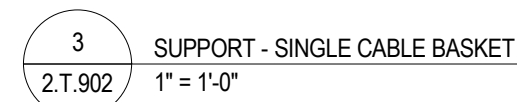
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SEALS AND SIGNATURES



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
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SEALS AND SIGNATURES



PROJECT NUMBER
 **2.T.902**
 SHEET NUMBER